	HEADQUARTERS SHEET LIST
Sheet	Sheet Name
0.1 GENERA	AL INFORMATION
G-000	COVER SHEET
G-001	PROJECT INFORMATION
G-002	PROJECT INFORMATION
1.1 MODULE	ES
MO101	MODULE - MEDIUM VEHICLE APPARATUS BAYS
MO102	MODULE - LARGE VEHICLE APPARATUS BAYS
MO103	MODULE - APPARATUS BAYS
MO104	MODULE - APPARATUS SUPPORT - SUITE
MO105	MODULE - APPARATUS SUPPORT - LINEAR
MO106	MODULE - BUILDING SUPPORT
MO107	MODULE - RESIDENTIAL - DAY ROOM
MO108	MODULE - RESIDENTIAL - RESTROOM
MO109	MODULE - RESIDENTIAL - DORM
MO110	MODULE - RESIDENTIAL - FITNESS & RECREATION
MO111	MODULE - RESIDENTIAL - HOTELING & LAUNDRY
MO112	MODULE - ADMINISTRATIVE - OFFICE LINEAR
MO113	MODULE - ADMINISTRATIVE - OFFICE SUITE
MO114	MODULE - ADMINISTRATIVE - TRAINING & TESTING
MO115	MODULE - ADMINISTRATIVE - LOGISTICS & DISPATCH
MO116	MODULE - ADMINISTRATIVE - RESERVE, LOBBY, BREAK RM
2.1 COMPO	
CO101	COMPOSITE A - LARGE HEADQUARTERS COMBINATION PROGRAM AND PERSPECTIVES
CO102	COMPOSITE A - LARGE HEADQUARTERS COMBINATION SITE
CO103	COMPOSITE A - LARGE HEADQUARTERS COMBINATION OVERALL FLOOR PLAN
CO104	COMPOSITE A - LARGE HEADQUARTERS COMBINATION ENLARGED FLOOR PLANS
CO105	COMPOSITE A - LARGE HEADQUARTERS COMBINATION ELEVATIONS
CO106	COMPOSITE B - LARGE HEADQUARTERS COMBINATION PROGRAM AND PERSPECTIVES
CO107	COMPOSITE B - LARGE HEADQUARTERS COMBINATION SITE
CO108	COMPOSITE B - LARGE HEADQUARTERS COMBINATION OVERALL FLOOR PLAN
CO109	COMPOSITE B - LARGE HEADQUARTERS COMBINATION ENLARGED FLOOR PLAN
CO110	COMPOSITE B - LARGE HEADQUARTERS COMBINATION ELEVATIONS
CO111	COMPOSITE A - HEADQUARTERS ARFF PROGRAM AND PERSPECTIVES
CO112	COMPOSITE A - HEADQUARTERS ARFF SITE
CO113	COMPOSITE A - HEADQUARTERS ARFF OVERALL FLOOR PLAN
CO114	COMPOSITE A - HEADQUARTERS ARFF ENLARGED FLOOR PLANS
CO115	COMPOSITE A - HEADQUARTERS ARFF ELEVATIONS
CO116	COMPOSITE B - HEADQUARTERS ARFF PROGRAM AND PERSPECTIVES
CO117	COMPOSITE B - HEADQUARTERS ARFF SITE
CO118	COMPOSITE B - HEADQUARTERS ARFF OVERALL FLOOR PLAN
CO119	COMPOSITE B - HEADQUARTERS ARFF ENLARGED FLOOR PLAN
CO120	COMPOSITE B - HEADQUARTERS ARFF ELEVATIONS
CO121	COMPOSITE A - HEADQUARTERS STRUCTURAL PROGRAM AND PERSPECTIVES
CO122	COMPOSITE A - HEADQUARTERS STRUCTURAL SITE
CO123	COMPOSITE A - HEADQUARTERS STRUCTURAL OVERALL FLOOR PLAN
CO124	COMPOSITE A - HEADQUARTERS STRUCTURAL ENLARGED FLOOR PLANS
CO125	COMPOSITE A - HEADQUARTERS STRUCTURAL ELEVATIONS
CO126	COMPOSITE B - HEADQUARTERS STRUCTURAL PROGRAM AND PERSPECTIVES
CO127	COMPOSITE B - HEADQUARTERS STRUCTURAL SITE
CO128	COMPOSITE B - HEADQUARTERS STRUCTURAL OVERALL FLOOR PLAN
CO129	COMPOSITE B - HEADQUARTERS STRUCTURAL ENLARGED FLOOR PLAN

U.S. AIR FORCE CIVIL ENGINEER CENTER (AFCEC)

FACILITIES DYNAMIC PROTOTYPES DESIGN FOR FIRE STATION - HEADQUARTERS

SUBMISSION:

REVISED FINAL

DATE:

DECEMBER 2013









NOT FOR CONSTRUCTION

Jacobs Project No.:

Drawing Title:

COVER SHEET

Designed By: LEG Drawn By: KLW Checked By: JW

Drawing No.: G-000

FUNCTIONS.

AS APPROPRIATE

CONSTRUCTION

911 Central Parkway N., Suite 425 San Antonio, TX 78323

CENTER (AFCEC)
YPES DESIGN FOR

TYPES OF STATIONS: FUNCTIONALLY, THERE ARE THREE TYPES OF FIRE STATIONS:


- **STRUCTURAL** STATIONS PROVIDE PROTECTION TO FACILITIES

CLASSES OF STATIONS: THERE ARE TWO CLASSES OF FIRE STATIONS:

• *HEADQUARTERS (OR MAIN) STATIONS GENERALLY HOUSE THE FIRE CHIEF AND MOST OF THE GENERAL ADMINISTRATIVE

SATELLITE STATIONS ARE LOCATED THROUGHOUT THE INSTALLATION TO PROVIDE ADEQUATE RESPONSE TIME COVERAGE,

- **COMBINATION** STRUCTURAL/ ARFF STATIONS
- ARFF AIRCRAFT RESCUE FIREFIGHTING STATIONS PROVIDE FIRE PROTECTION TO FLIGHLINES AND AIRCRAFT

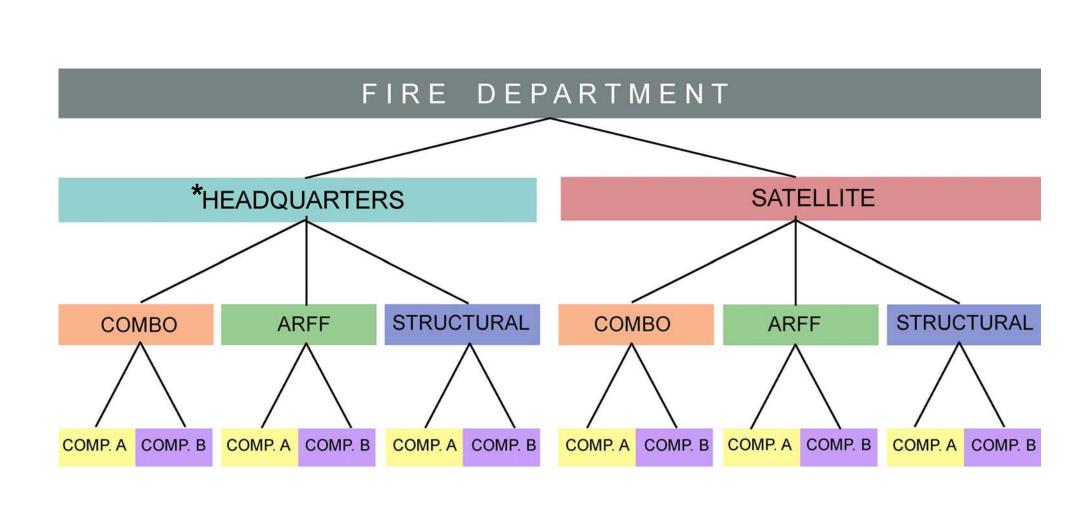

*LARGE HEADQUARTER STATIONS ARE VERY LARGE COMBINATION STATIONS THAT TYPICALLY SERVE AN ENTIRE INSTALLATION WITHOUT SATELLITE STATIONS

DIAGRAM 1

THE FIRE STATION(S) MISSION: PROVIDES FIRE PROTECTION TO INSTALLATION FLIGHTLINES, STRUCTURAL FACILITIES AND

THE FACILITY WILL HOST, AN APPARATUS BAY FUNCTION, A DAY ROOM & RESIDENTIAL FUNCTION, A TRAINING &

MAINTENANCE **APPARATUS**

APPARATUS

DAY

ADMINISTRATIVE FUNCTION, AN EMERGENCY CONTROL CENTER (DISPATCH FUNCTION), AND VARIOUS SITE RELATED

FIRE STATION BUBBLE DIAGRAM: THIS ILLUSTRATIVE DIAGRAM BELOW DOES NOT REPRESENT MANDATORY OR EVEN SUGGESTED LAYOUTS AND IS PROVIDED TO ILLUSTRATE THE RELATIVE SIZES OF THE FUNCTIONAL SPACES ALONG WITH ACCEPTABLE ADJACENCIES. MINOR SUPPORT AREAS, INFRASTRUCTURE AND SITE SUPPORT FUNCTIONS HAVE BEEN INTENTIONALLY LEFT OUT IN AN EFFORT TO SHOW MAJOR ADJACENCY REQUIREMENTS. ALL REQUIRED SPACES SHOULD BE DESIGNED ON A CASE BY CASE BASIS.

DIAGRAM 2

Jacobs Project No.: Drawing Title:

PROJECT INFORMATION

DECEMBER 2013

Designed By:LEG Drawn By: KLW Checked By: JW

G-001

Drawing No.:

FDYD3106

SCOPE OF THE FACILITY:

FIRE PREVENTION EDUCATION AND TRAINING.

SUPPORT FUNCTIONS. (DIAGRAM 1)

FITNESS

DORMS

RR/LOCKERS

RECREATION

LAUNDRY

RESERVE

LOGISTICS

DISPATCH

TYPES OF FIRE STATIONS:

CLASS OF FIRE STATIONS:

VEST.

LOBBY

ADMINISTRATION

OFFICES

TRAINING &

P-18/26 Water Tanker

Prototype Fire Station

P-23 Crash Truck (3,000	gal)			1		1	3	3		Large ARF	F
P-19 Crash Truck (1,500 gal)					1		1	3	3	N	ledium AR	F
P-34 RIV (500 gal)					1		1	2	2			
P-31 HazMat Vehicle					1		1	1	1	Medium Structural		
Chief 1 - Command and Control Vehicle					1		1	1	1	Small		
Chief 2 - Command and Control Vehicle				1		1	1	1	Small			
			Tota	al Cou	nts:		9		21			
Use Nos. No		t.					Bay S	Sizes				
Above:	Ç.	Total Ct.	Length		Width							
Vehicle Size					Single Bay			Middle Bay			End Bay	
Class	Alt.	To	m	ft	mn	n	ft	m	m	ft	mm	ft
Small	4	4										
Med. Struct.	7	7	14630	48	146	30	22	67	06	17	5944	19.5
Lg. Struct.												
Med. ARFF	6	6	14630	48	146	30	24	73	15	19.5	6706	22
Lg. ARFF												
Largest Dimension					6706	22						
Apparatus Bay Ar	.03.			m ²	2	14.04	1	•	107.02	2	98.11	
Apparatus bay Ai	ft			ft ²	1152			936			1056	
** Bay size includes a	rea req	uired a	round vehicle. I	Bay size	es are dr	iven b	y larges	t vehic	e selec	ted, i.e.	, if at least 1 l	arge

ARFF truck is entered, all bays will accommodate that size truck. See Para. 2-2.2-1 for more information.

THE INTERACTIVE WORKSHEET: ESTABLISHES SQUARE FOOTAGE REQUIREMENTS BASED ON INFORMATION PROVIDED BY THE USER


* This suggested area must be carefully reviewed by the planning team. Review

Provide additional Bays for Small vehicles:

15 Bays Currently Programmed

APPARATUS BAYS

ADMINISTRATION

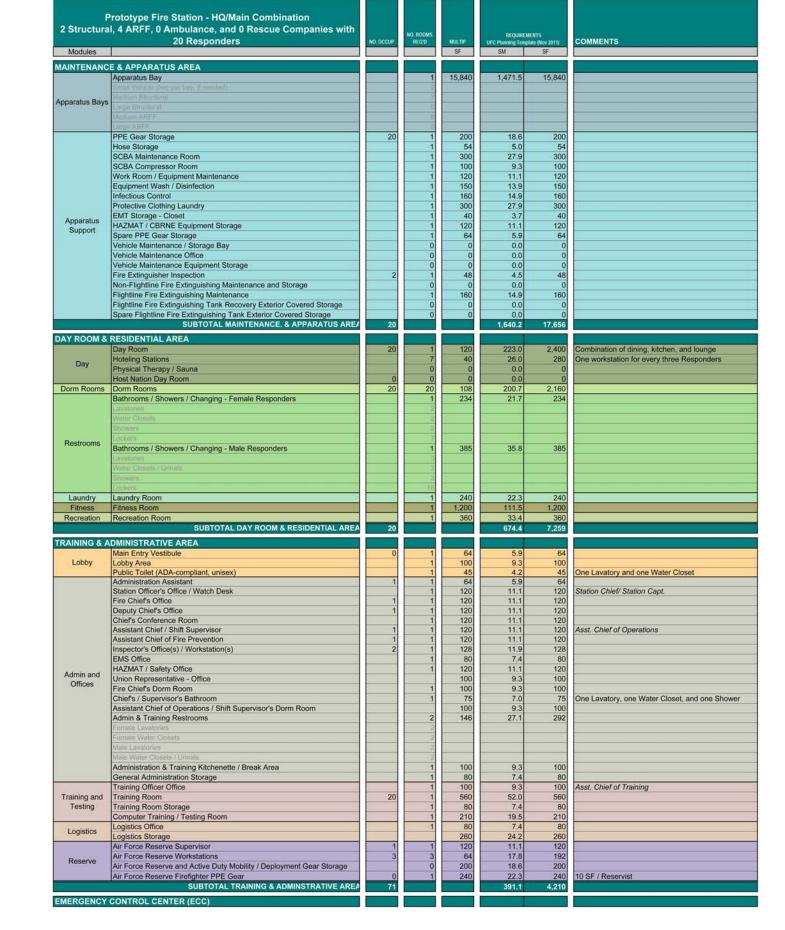

THE PREDESIGN AREA MATRIX:

PROVIDES THE PROGRAMMATIC AND SQUARE FOOTAGE REQUIREMENTS FOR EACH FACILITY.





AGENT

TRAINING AND

TESTING

STORAGE

Medium Structural

Number (2 suggested): 2

Provide additional Apparatus Bays: No Number:

APPARATUS

TRAINING AND

TESTING


SUPPORT

FITNESS

LOGISTICS

DAYROOM


RESERVE

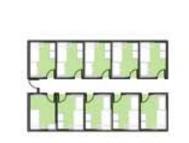

DORM

DISPATCH

(ECC)

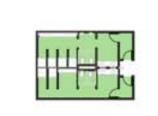

RESPONDER

RESTROOM



RESTROOM

HOTELING



LAUNDRY

RECREATION



LOBBY/ VESTIBULE

Jacobs Project No.:

AIR FORCE CIVIL ENGINEER CENTER (AFCEC) FACILITIES DYNAMIC PROTOTYPES DESIGN FOR

ATION

JARTER

HEADQU

Drawing Title:

PROJECT INFORMATION

FDYD3106

Drawing No.:

G-002

JACOBS

NOT FOR

CONSTRUCTION

911 Central Parkway N., Suite 425 San Antonio, TX 78323 501 North Broadway, St. Louis, Missouri 63102-2121

DECEMBER 2013 Date:


Designed By:LEG Drawn By: KLW Checked By: JW


BREAK

ROOM

MODULES HAVE BEEN GENERATED USING THE RECOMMENDED SQUARE FOOTAGES PRODUCED BY THE INTERACTIVE WORKSHEET. MODULES ARE THEN PUT TOGETHER BASED ON ADJACENCY REQUIREMENTS TO CREATE AN OVERALL BUILDING FLOOR PLAN.

Checked By: JW

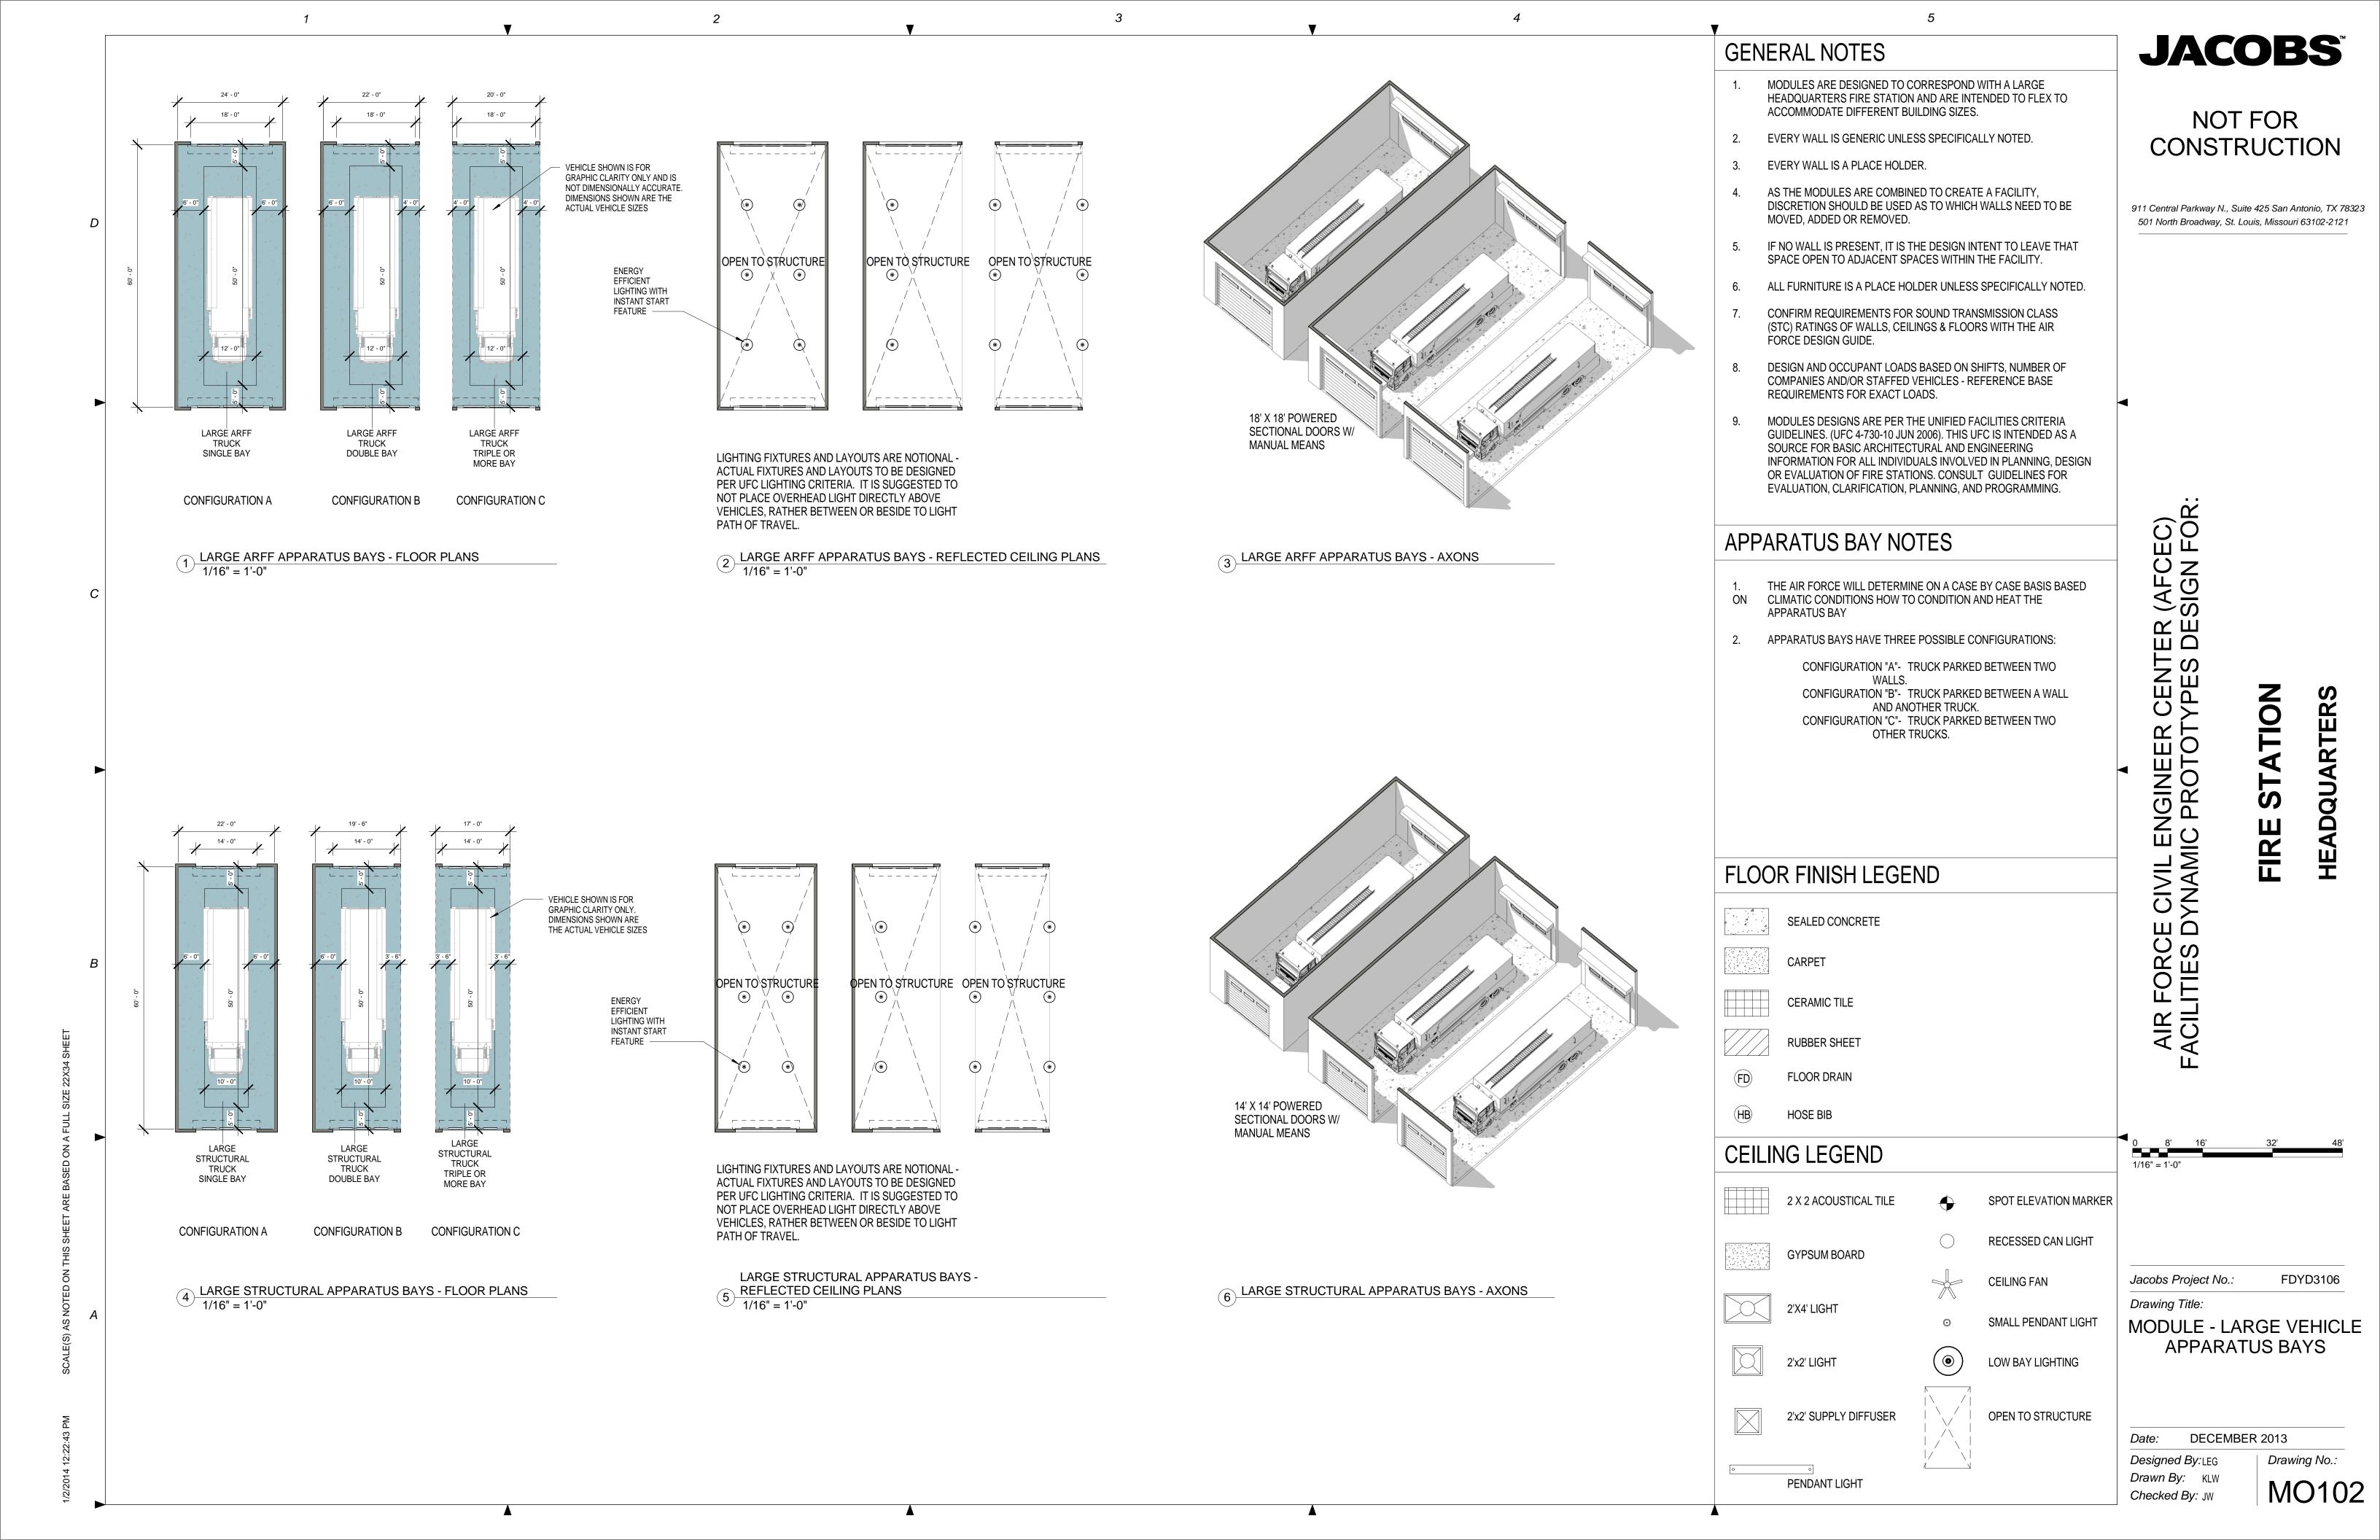

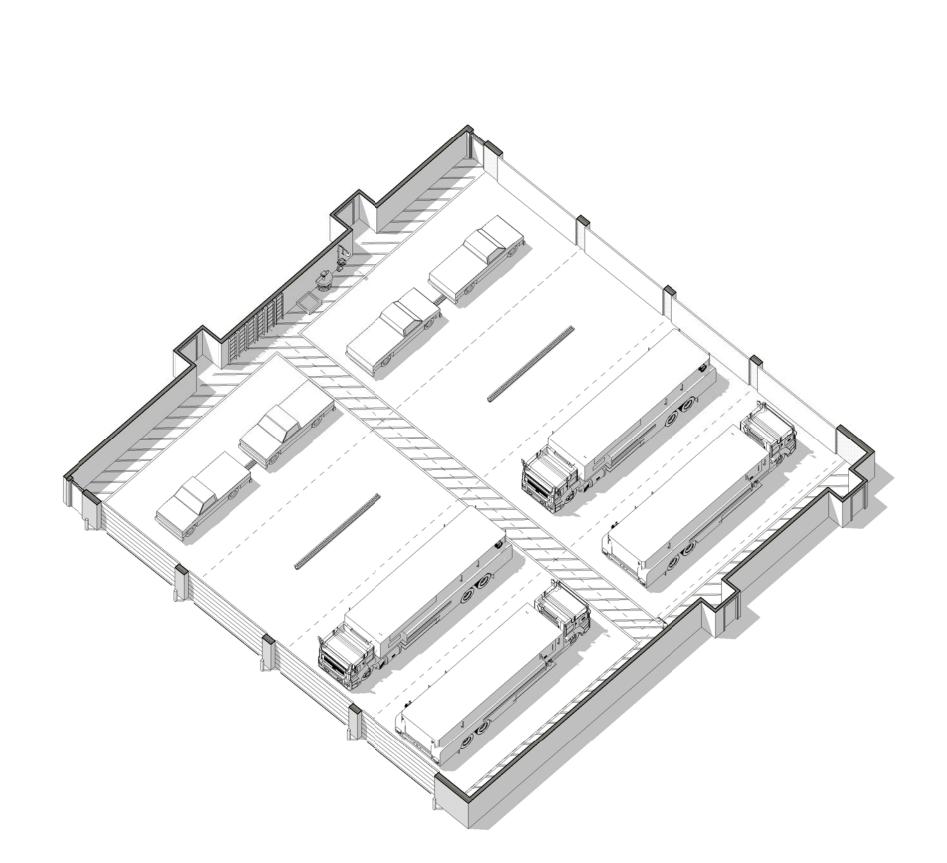

3 APPARATUS BAY MODULE - AXON

• • • • OPEN TO STRUCTURÉ • • • • • • • • () ______ APPARATUS BAY -2 REFLECTED CEILING PLAN
1/16" = 1'-0"

GENERAL NOTES

- MODULES ARE DESIGNED TO CORRESPOND WITH A LARGE HEADQUARTERS FIRE STATION AND ARE INTENDED TO FLEX TO ACCOMMODATE DIFFERENT BUILDING SIZES.
- EVERY WALL IS GENERIC UNLESS SPECIFICALLY NOTED.
 - EVERY WALL IS A PLACE HOLDER.
- AS THE MODULES ARE COMBINED TO CREATE A FACILITY, DISCRETION SHOULD BE USED AS TO WHICH WALLS NEED TO BE MOVED, ADDED OR REMOVED.
- IF NO WALL IS PRESENT, IT IS THE DESIGN INTENT TO LEAVE THAT SPACE OPEN TO ADJACENT SPACES WITHIN THE FACILITY.
- ALL FURNITURE IS A PLACE HOLDER UNLESS SPECIFICALLY NOTED.
- CONFIRM REQUIREMENTS FOR SOUND TRANSMISSION CLASS (STC) RATINGS OF WALLS, CEILINGS & FLOORS WITH THE AIR FORCE DESIGN GUIDE.
- DESIGN AND OCCUPANT LOADS BASED ON SHIFTS, NUMBER OF COMPANIES AND/OR STAFFED VEHICLES - REFERENCE BASE REQUIREMENTS FOR EXACT LOADS.
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APPARATUS BAY NOTES

- ALL BAYS MUST ACCOMMODATE THE LARGEST VEHICLE AND CONTAIN REQUIRED SUPPORT UTILITIES PER THE UFC.
- DRIVE THROUGH BAYS ARE PREFERABLE.
- BOLLARDS ARE REMOVABLE AND ARE NOTIONALLY REPRESENTED. LOCATION OF BOLLARDS SHOULD BE CASE SPECIFIC AND FOLLOW UFC GUIDELINES.
- HEIGHT OF BAYS DETERMINED BY VEHICLE AND EQUIPMENT REQUIREMENTS PER THE UFC.
 - THIS IS A NOTIONAL CONFIGURATION/LAYOUT.

FLOOR FINISH LEGEND

SEALED CONCRETE

RUBBER SHEET

CERAMIC TILE

FLOOR DRAIN

HOSE BIB

CEILING LEGEND

2 X 2 ACOUSTICAL TILE

SPOT ELEVATION MARKER



RECESSED CAN LIGHT



SMALL PENDANT LIGHT



2'x2' SUPPLY DIFFUSER

PENDANT LIGHT

2'X4' LIGHT

LOW BAY LIGHTING





OPEN TO STRUCTURE

DECEMBER 2013

Designed By: LEG Drawn By: KLW Checked By: JW

Jacobs Project No.:

Drawing Title:

JACOBS

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CONSTRUCTION

911 Central Parkway N., Suite 425 San Antonio, TX 78323

501 North Broadway, St. Louis, Missouri 63102-2121

FER (AFCEC) DESIGN FOR:

AIR FORCE CIVII FACILITIES DYNAN

NOL

RTER

MO103


Drawing No.:

FDYD3106


MODULE - APPARATUS

BAYS

1 APPARATUS SUPPORT MODULE - FLOOR PLAN 1/8" = 1'-0"

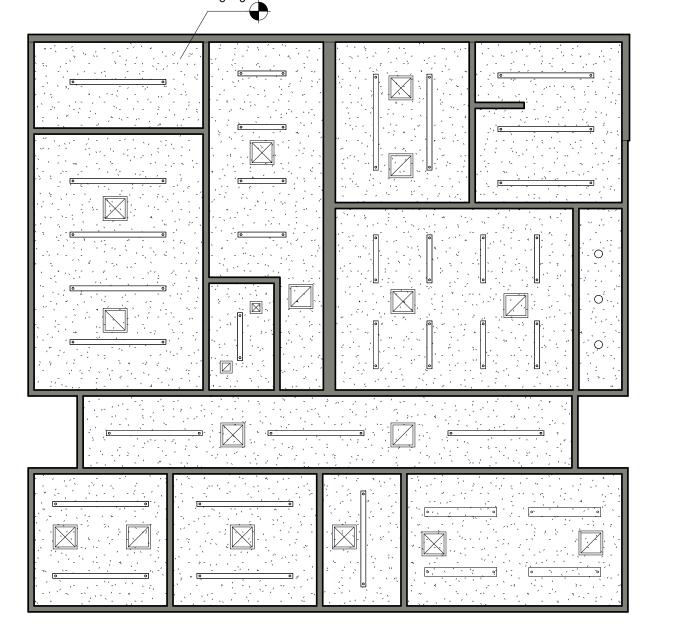

2 APPARATUS SUPPORT MODULE - REFLECTED CEILING PLAN
1/8" = 1'-0" 1/8" = 1'-0"

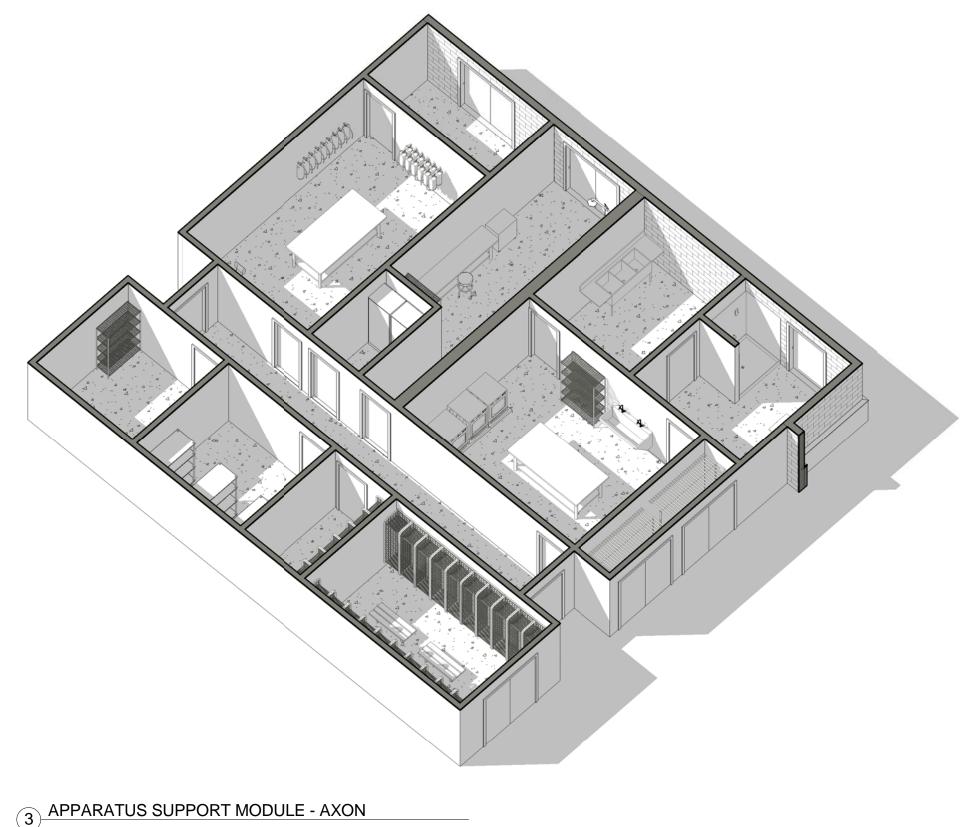

PPE GEAR STORAGE LOCKERS

- MODULES ARE DESIGNED TO CORRESPOND WITH A LARGE HEADQUARTERS FIRE STATION AND ARE INTENDED TO FLEX TO
- EVERY WALL IS A PLACE HOLDER.
- AS THE MODULES ARE COMBINED TO CREATE A FACILITY, DISCRETION SHOULD BE USED AS TO WHICH WALLS NEED TO BE MOVED, ADDED OR REMOVED.
- IF NO WALL IS PRESENT, IT IS THE DESIGN INTENT TO LEAVE THAT SPACE OPEN TO ADJACENT SPACES WITHIN THE FACILITY.
- ALL FURNITURE IS A PLACE HOLDER UNLESS SPECIFICALLY NOTED.
- CONFIRM REQUIREMENTS FOR SOUND TRANSMISSION CLASS (STC) RATINGS OF WALLS, CEILINGS & FLOORS WITH THE AIR FORCE DESIGN GUIDE.
- DESIGN AND OCCUPANT LOADS BASED ON SHIFTS, NUMBER OF COMPANIES AND/OR STAFFED VEHICLES - REFERENCE BASE REQUIREMENTS FOR EXACT LOADS.
- MODULES DESIGNS ARE PER THE UNIFIED FACILITIES CRITERIA GUIDELINES. (UFC 4-730-10 JUN 2006). THIS UFC IS INTENDED AS A SOURCE FOR BASIC ARCHITECTURAL AND ENGINEERING INFORMATION FOR ALL INDIVIDUALS INVOLVED IN PLANNING, DESIGN OR EVALUATION OF FIRE STATIONS. CONSULT GUIDELINES FOR EVALUATION, CLARIFICATION, PLANNING, AND PROGRAMMING.

APPARATUS SUPPORT NOTES

- ALL CEILINGS ARE A MIN. OF 9'-0" UNLESS OTHERWISE NOTED.
- ADJACENCIES BETWEEN INFECTIOUS CONTROL, EQUIPMENT WASH AND DISINFECTION, AND PROTECTIVE CLOTHING LAUNDRY SHOULD BE MAINTAINED. INFECTIOUS CONTROL REQUIRES DIRECT ACCESS TO EXTERIOR AND APPARATUS BAYS.
- ARFF FACILITIES REQUIRE EXTERIOR COVERED STORAGE VERIFY PROGRAM AND SQUARE FOOTAGE REQUIREMENTS AS NEEDED.

FLOOR FINISH LEGEND

SEALED CONCRETE

CERAMIC TILE

CARPET

RUBBER SHEET

FLOOR DRAIN

GYPSUM BOARD

2'X4' LIGHT

2'x2' LIGHT

2'x2' SUPPLY DIFFUSER

PENDANT LIGHT

HOSE BIB

CEILING LEGEND

2 X 2 ACOUSTICAL TILE

SPOT ELEVATION MARKER

CEILING FAN



RECESSED CAN LIGHT





SMALL PENDANT LIGHT



LOW BAY LIGHTING



OPEN TO STRUCTURE

DECEMBER 2013

MODULE - APPARATUS

SUPPORT - SUITE

JACOBS[™]

NOT FOR

CONSTRUCTION

911 Central Parkway N., Suite 425 San Antonio, TX 78323

501 North Broadway, St. Louis, Missouri 63102-2121

FER (AFCEC) DESIGN FOR:

CENT

AIL ENGINEER (AMIC PROTOTY

AIR FORCE CIVII FACILITIES DYNAN

MOL

4

ARTER


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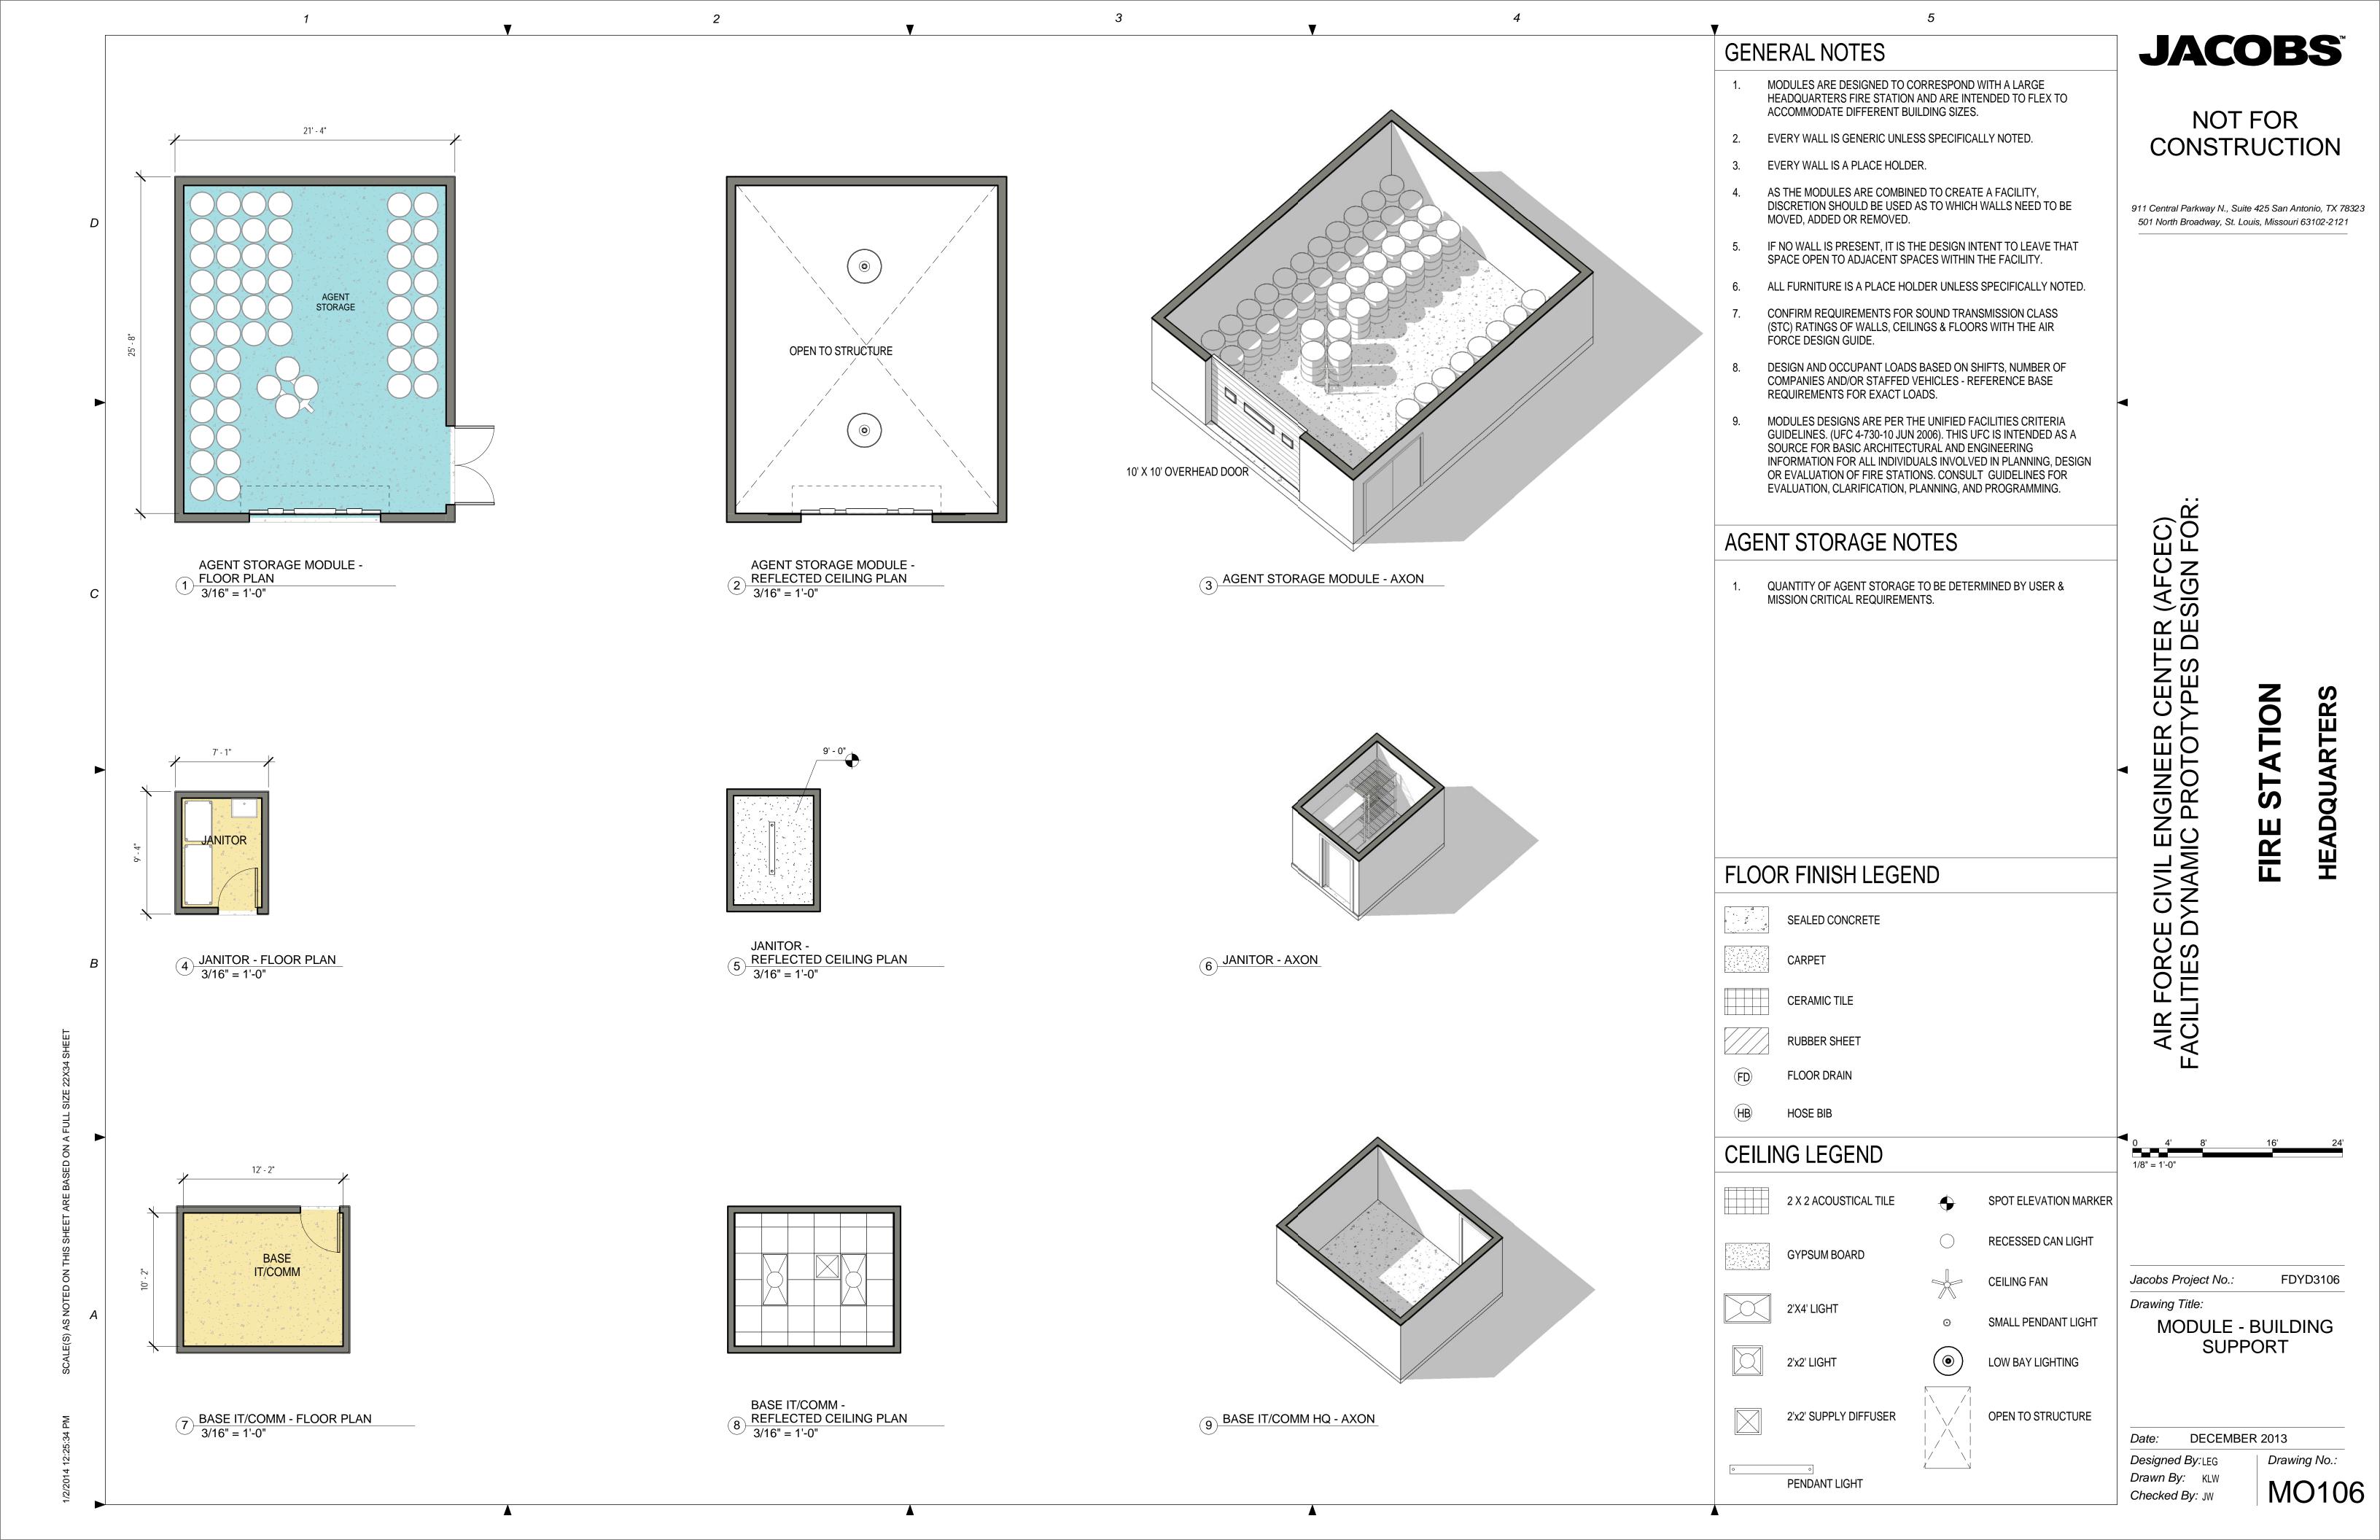
Designed By: LEG Drawn By: KLW Checked By: JW

Jacobs Project No.:

Drawing Title:

Drawing No.: MO104



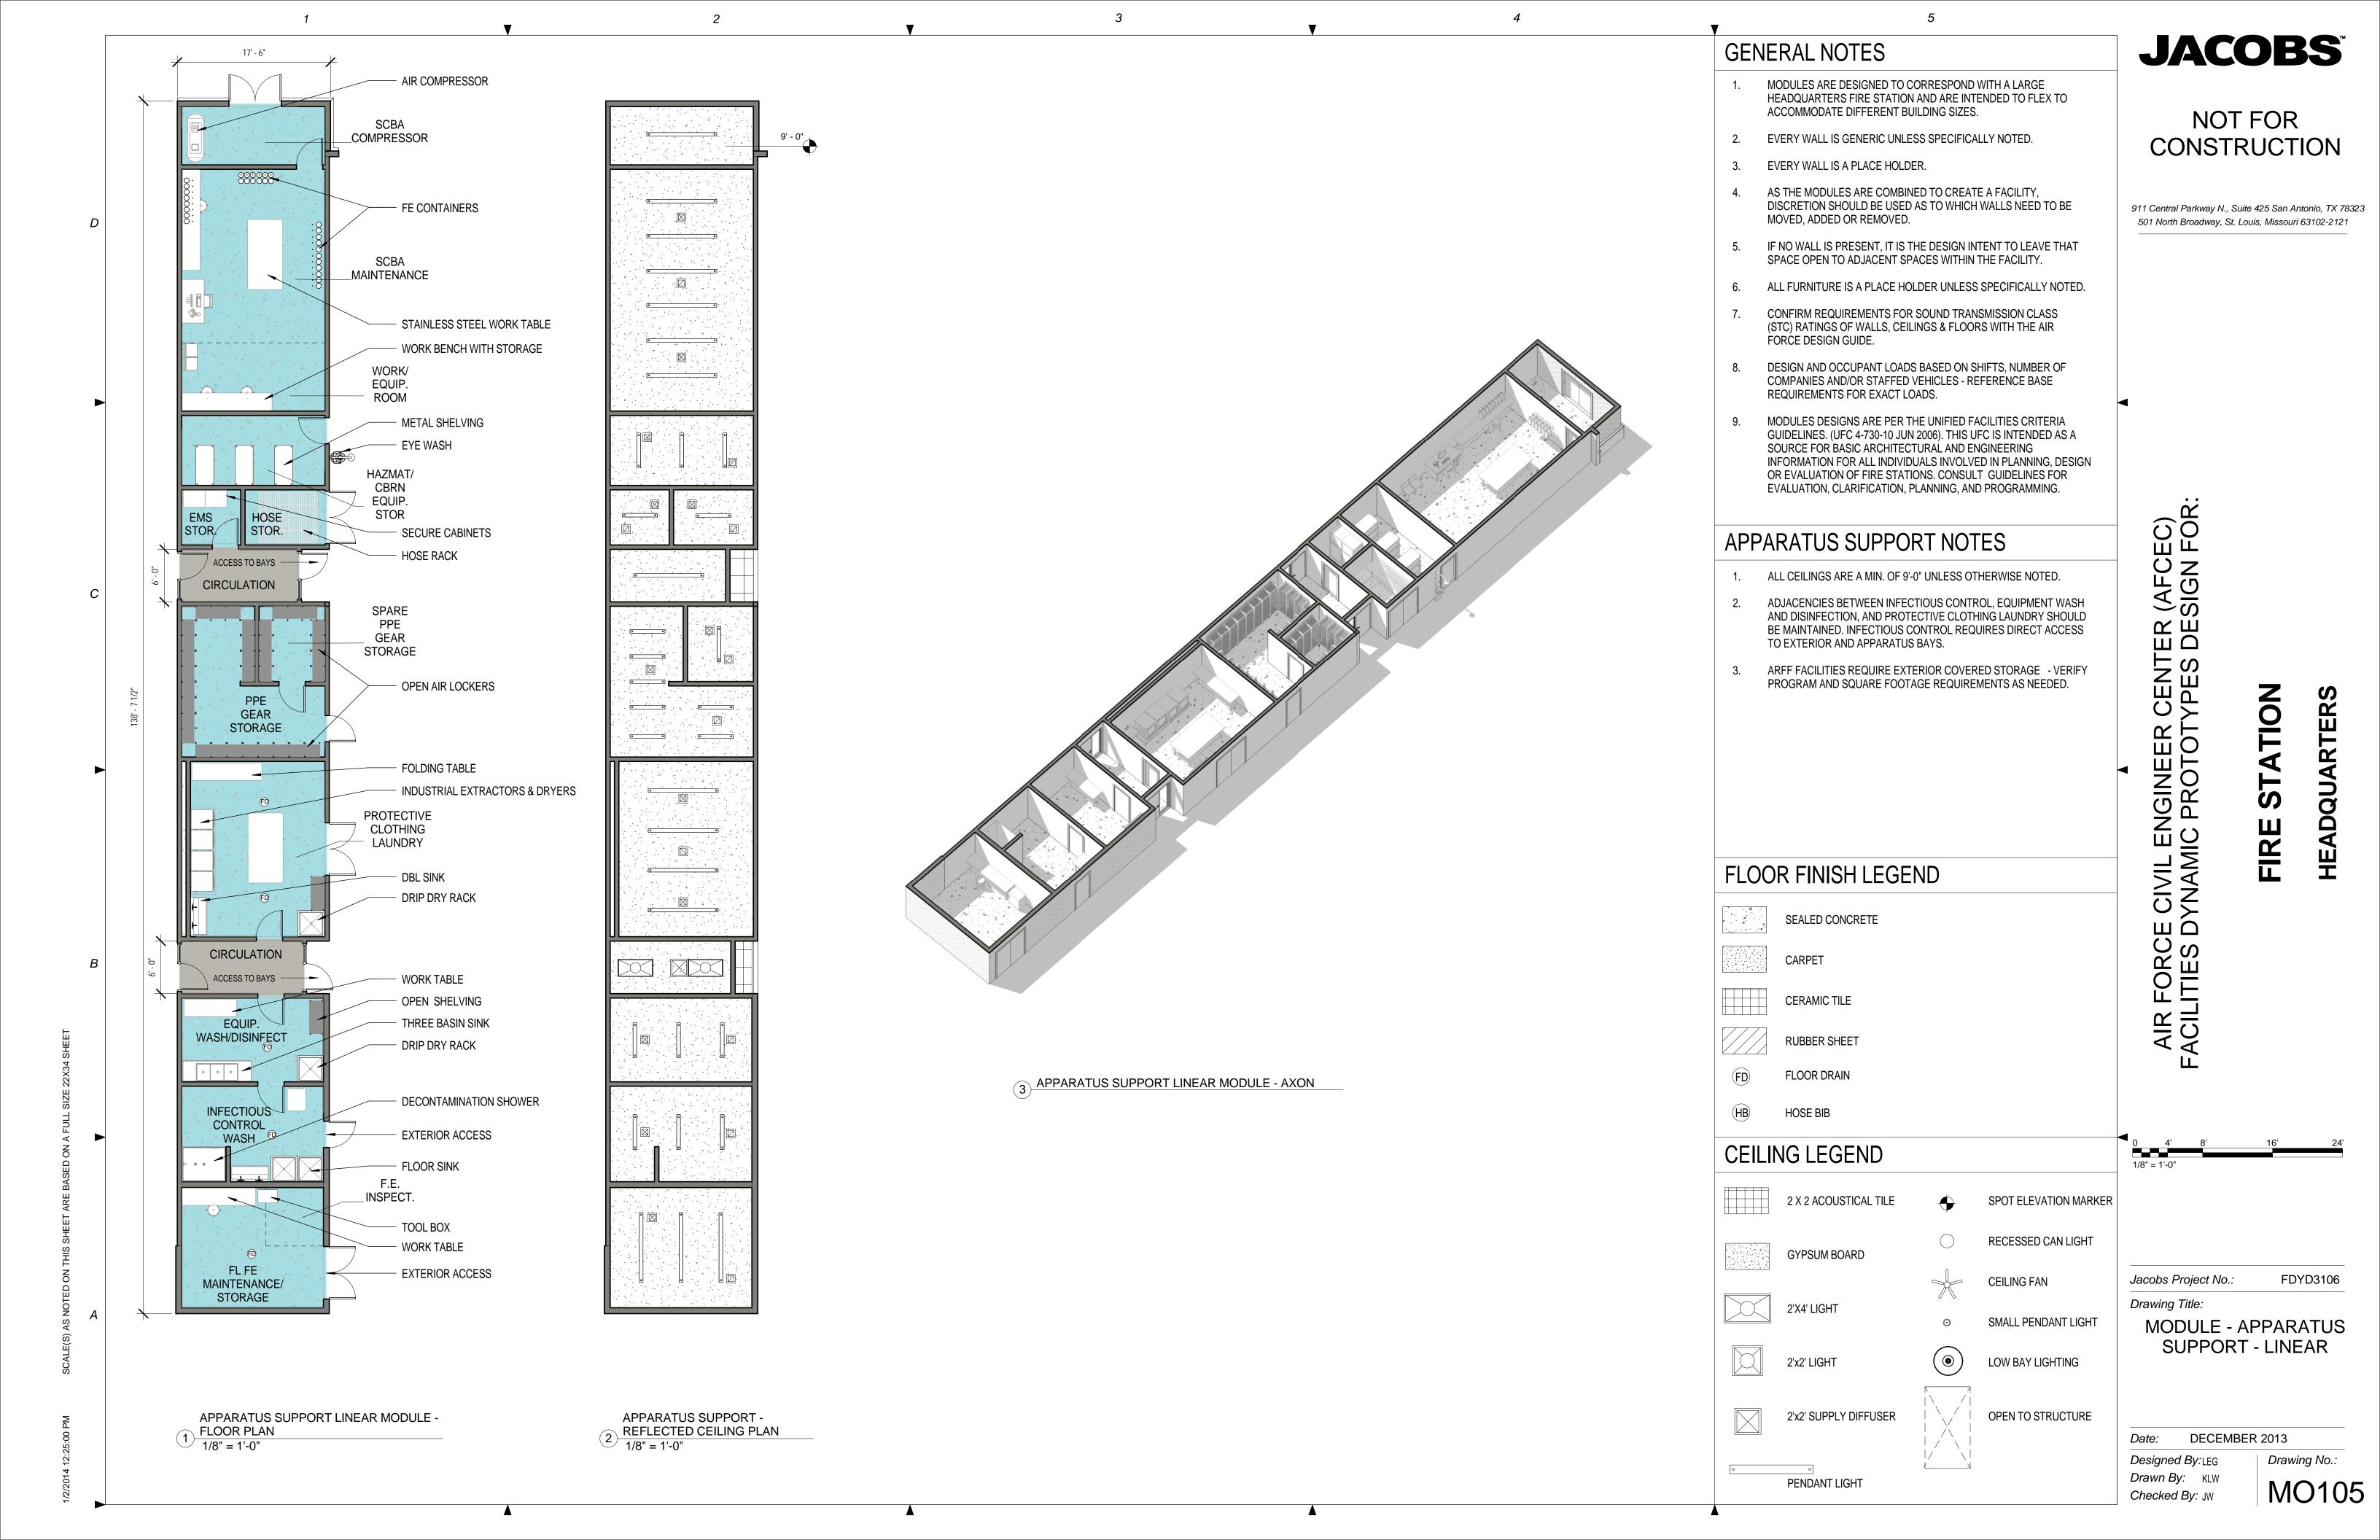

JACOBS

NOT FOR

911 Central Parkway N., Suite 425 San Antonio, TX 78323 501 North Broadway, St. Louis, Missouri 63102-2121

CONSTRUCTION

FER (AFCEC) DESIGN FOR:

MOL

ARTER

Q

AIR FORCE CIVII FACILITIES DYNAN

Jacobs Project No.: **CEILING FAN** Drawing Title:

SMALL PENDANT LIGHT

LOW BAY LIGHTING

PENDANT LIGHT

OPEN TO STRUCTURE


DECEMBER 2013

Drawing No.: Designed By:LEG Drawn By: KLW Checked By: JW


MODULE - RESIDENTIAL -

DAY ROOM


MO107

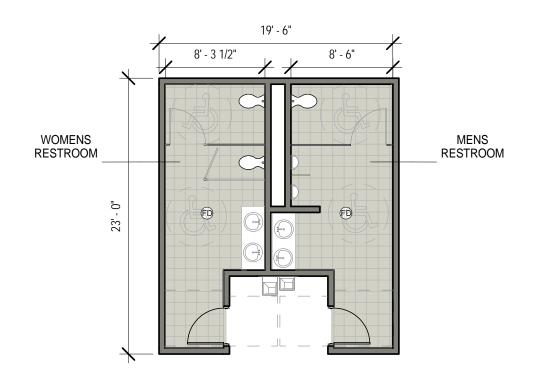

ADMINISTRATION RESTROOMS -4 FLOOR PLAN 1/8" = 1'-0"

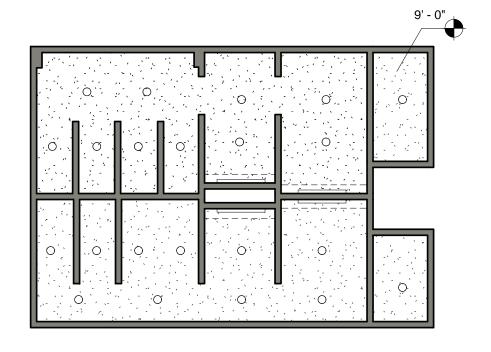

RESPONDERS RESTROOMS REFLECTED CEILING PLAN
1/8" = 1'-0"

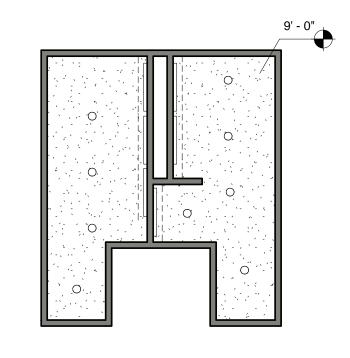


ADMINISTRATION RESTROOMS -(5) REFLECTED CEILING PLAN 1/8" = 1'-0"



RESPONDER RESTROOM - LOCKER RM

(3) RESPONDERS RESTROOMS - AXON

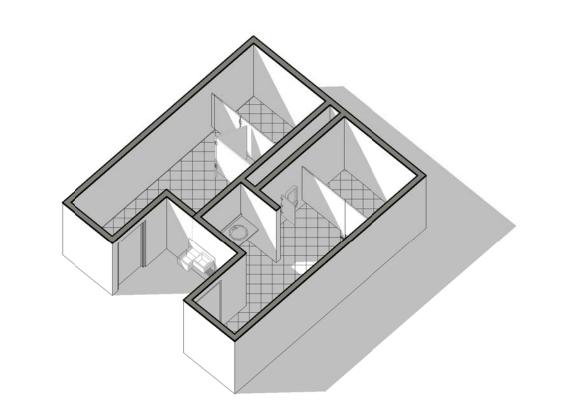

6 ADMINISTRATION RESTROOMS - AXON



RESPONDER RESTROOM

- MODULES ARE DESIGNED TO CORRESPOND WITH A LARGE HEADQUARTERS FIRE STATION AND ARE INTENDED TO FLEX TO ACCOMMODATE DIFFERENT BUILDING SIZES.
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RESTROOM NOTES

CONSULT WITH USER AND LOCAL CODES FOR FINAL FIXTURE COUNTS IN RESPONDER RESTROOM. CONSIDER THE HEAVY, CONCENTRATED USAGE OF FACILITY AFTER A CALL.

FLOOR FINISH LEGEND

SEALED CONCRETE

CERAMIC TILE

CARPET

RUBBER SHEET

FLOOR DRAIN

CEILING LEGEND

HOSE BIB

2 X 2 ACOUSTICAL TILE

SPOT ELEVATION MARKER



RECESSED CAN LIGHT

CEILING FAN



SMALL PENDANT LIGHT



GYPSUM BOARD


2'X4' LIGHT

2'x2' SUPPLY DIFFUSER

PENDANT LIGHT



LOW BAY LIGHTING

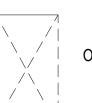



OPEN TO STRUCTURE

DECEMBER 2013

MODULE - RESIDENTIAL -

RESTROOM

JACOBS

NOT FOR

CONSTRUCTION

911 Central Parkway N., Suite 425 San Antonio, TX 78323

501 North Broadway, St. Louis, Missouri 63102-2121

FER (AFCEC) DESIGN FOR:

AIR FORCE CIVIL ENGINEER FACILITIES DYNAMIC PROTOT

MOL

ARTERS

Designed By:LEG Drawn By: KLW Checked By: JW


Jacobs Project No.:

Drawing Title:

Drawing No.: MO108

1) DORM ROOM - FLOOR PLAN 1/8" = 1'-0"

2 DORM ROOM - REFLECTED CEILING PLAN 1/8" = 1'-0"

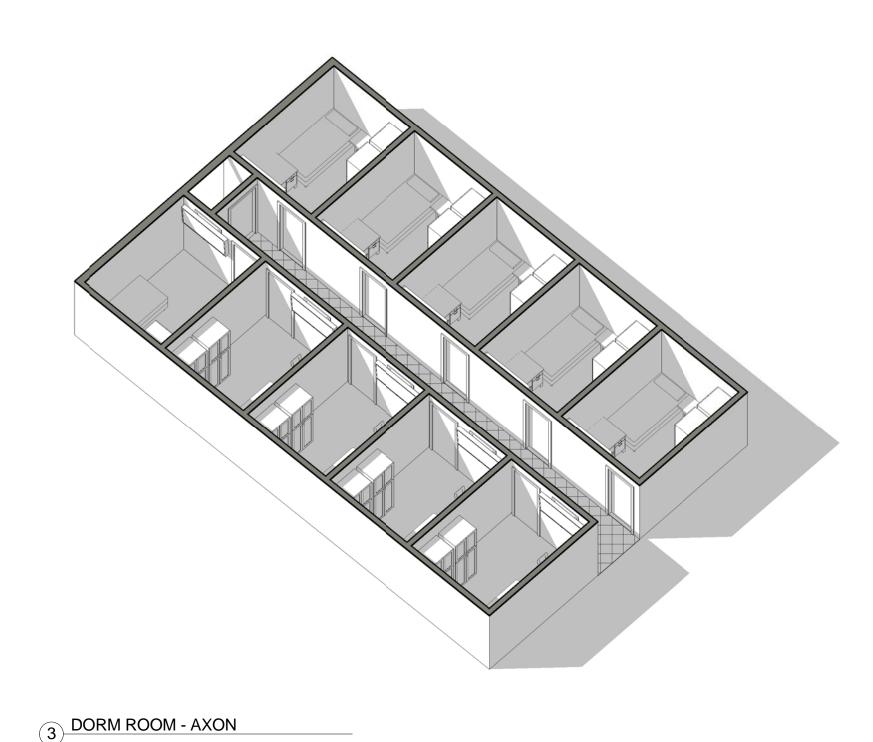



GENERAL NOTES

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DORM ROOM NOTES

- BED IS SHARED BETWEEN TWO SHIFTS, WITH LINENS REPLACED AFTER EACH SHIFT.
- EACH FIREFIGHTER HAS HIS/HER OWN LOCKABLE WARDROBE.
- NUMBER OF DORMS DEPENDANT UPON NUMBER OF RESPONDERS ON DUTY. INCLUDE DORM FOR STATION OFFICER. STATION OFFICER'S OFFICE SHOULD HAVE DIRECT ACCESS TO DORM WHEN POSSIBLE.
- 4. CONFIGURATION IS A NOTIONAL LAYOUT.

FLOOR FINISH LEGEND

SEALED CONCRETE

CERAMIC TILE

RUBBER SHEET

FLOOR DRAIN HOSE BIB

CEILING LEGEND

2 X 2 ACOUSTICAL TILE

2'X4' LIGHT

SPOT ELEVATION MARKER

GYPSUM BOARD

RECESSED CAN LIGHT

CEILING FAN



SMALL PENDANT LIGHT




2'x2' SUPPLY DIFFUSER

PENDANT LIGHT



LOW BAY LIGHTING

OPEN TO STRUCTURE

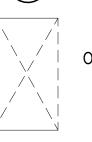

DECEMBER 2013

MODULE - RESIDENTIAL -

DORM

JACOBS

NOT FOR

CONSTRUCTION

911 Central Parkway N., Suite 425 San Antonio, TX 78323

501 North Broadway, St. Louis, Missouri 63102-2121

FER (AFCEC) DESIGN FOR:

AIR FORCE CIVIL ENGINEER CENT FACILITIES DYNAMIC PROTOTYPES

MOL

ARTER

Q

Drawn By: KLW Checked By: JW

Jacobs Project No.:


Drawing Title:

MO109


FDYD3106

Designed By: LEG


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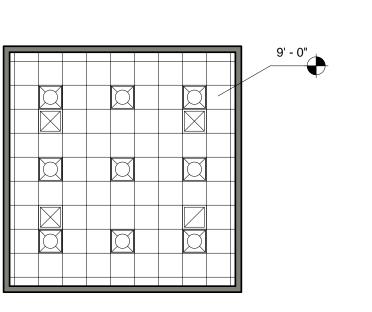
4 RECREATION ROOM - FLOOR PLAN 1/8" = 1'-0"

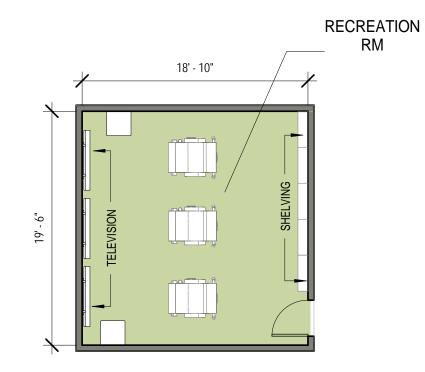


2 FITNESS - REFLECTED CEILING PLAN 1/8" = 1'-0"

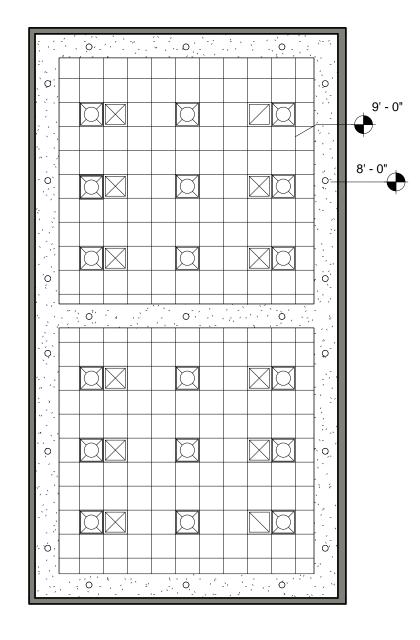

(3) FITNESS - AXON

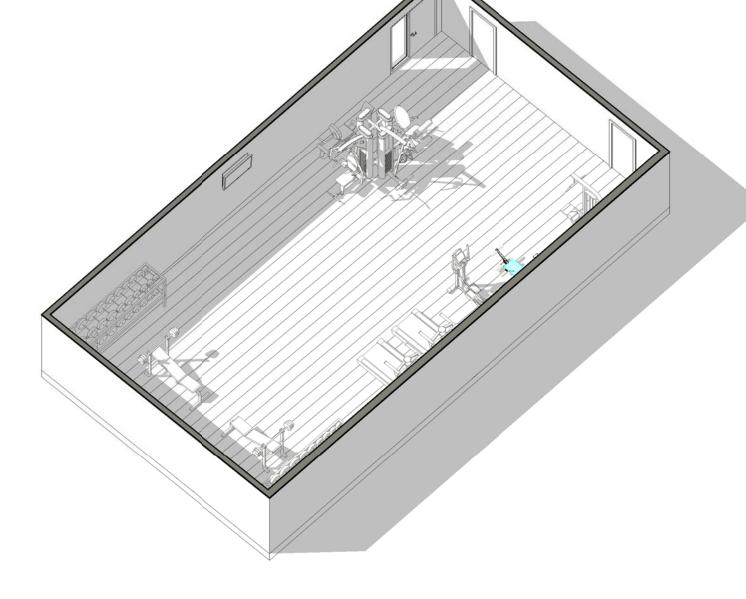


RECREATION ROOM REFLECTED CEILING PLAN
1/8" = 1'-0"

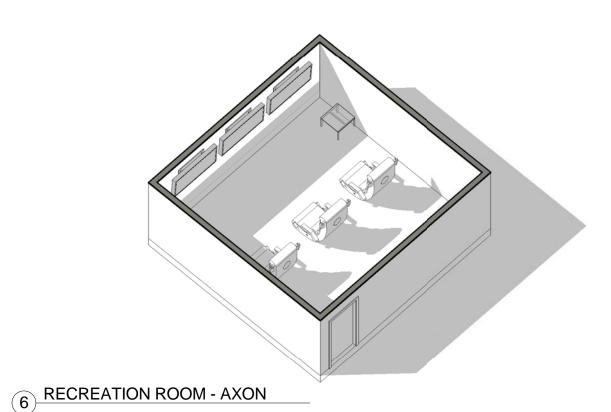



FITNESS ROOM

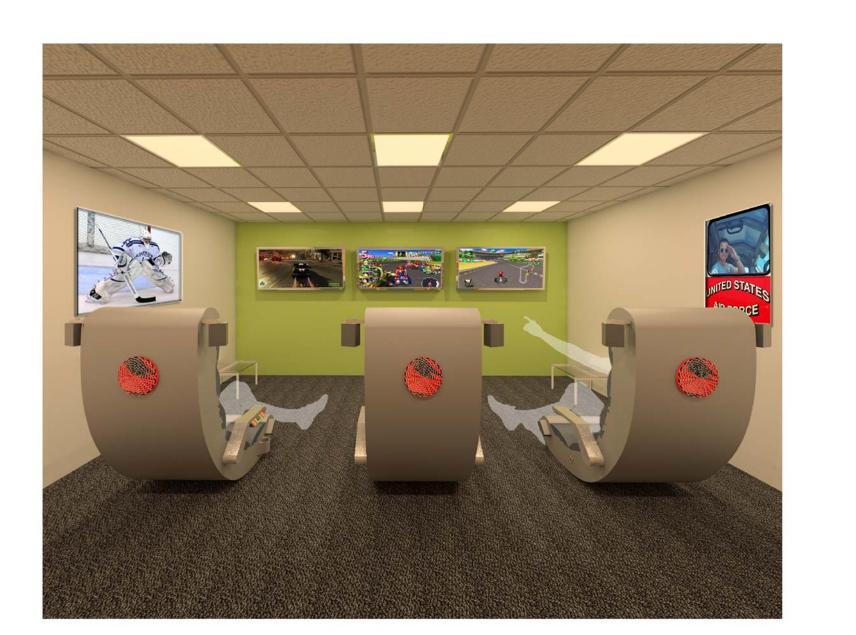

RECREATION ROOM

GENERAL NOTES

- MODULES ARE DESIGNED TO CORRESPOND WITH A LARGE HEADQUARTERS FIRE STATION AND ARE INTENDED TO FLEX TO ACCOMMODATE DIFFERENT BUILDING SIZES.
- EVERY WALL IS GENERIC UNLESS SPECIFICALLY NOTED.
- EVERY WALL IS A PLACE HOLDER.
- AS THE MODULES ARE COMBINED TO CREATE A FACILITY, DISCRETION SHOULD BE USED AS TO WHICH WALLS NEED TO BE MOVED, ADDED OR REMOVED.
- IF NO WALL IS PRESENT, IT IS THE DESIGN INTENT TO LEAVE THAT SPACE OPEN TO ADJACENT SPACES WITHIN THE FACILITY.
- ALL FURNITURE IS A PLACE HOLDER UNLESS SPECIFICALLY NOTED.
- CONFIRM REQUIREMENTS FOR SOUND TRANSMISSION CLASS (STC) RATINGS OF WALLS, CEILINGS & FLOORS WITH THE AIR FORCE DESIGN GUIDE.
- DESIGN AND OCCUPANT LOADS BASED ON SHIFTS, NUMBER OF COMPANIES AND/OR STAFFED VEHICLES - REFERENCE BASE REQUIREMENTS FOR EXACT LOADS.
- MODULES DESIGNS ARE PER THE UNIFIED FACILITIES CRITERIA GUIDELINES. (UFC 4-730-10 JUN 2006). THIS UFC IS INTENDED AS A SOURCE FOR BASIC ARCHITECTURAL AND ENGINEERING INFORMATION FOR ALL INDIVIDUALS INVOLVED IN PLANNING, DESIGN OR EVALUATION OF FIRE STATIONS. CONSULT GUIDELINES FOR EVALUATION, CLARIFICATION, PLANNING, AND PROGRAMMING.

FITNESS ROOM NOTES

FITNESS ROOM EQUIPMENT TO BE DETERMINED BY USER AND/OR FITNESS REQUIREMENTS.

RECREATION ROOM NOTES

POOL TABLES AND OTHER GAMING TABLES ARE OPTIONAL IN THIS SPACE. TO BE DETERMINED ON A CASE-BY-CASE BASIS.

FLOOR FINISH LEGEND

SEALED CONCRETE

CERAMIC TILE

RUBBER SHEET

FLOOR DRAIN HOSE BIB

CEILING LEGEND



2 X 2 ACOUSTICAL TILE



SPOT ELEVATION MARKER



RECESSED CAN LIGHT



SMALL PENDANT LIGHT



2'x2' SUPPLY DIFFUSER

2'x2' LIGHT

PENDANT LIGHT

2'X4' LIGHT

GYPSUM BOARD



LOW BAY LIGHTING



OPEN TO STRUCTURE

DECEMBER 2013

Jacobs Project No.:

Drawing Title:

Designed By: LEG

MODULE - RESIDENTIAL -

FITNESS & RECREATION

JACOBS

NOT FOR

CONSTRUCTION

911 Central Parkway N., Suite 425 San Antonio, TX 78323

501 North Broadway, St. Louis, Missouri 63102-2121

IL ENGINEER CENTER (AFCEC)
AMIC PROTOTYPES DESIGN FOR


AIR FORCE CIVII FACILITIES DYNAN


MOL

MO110 Checked By: JW

Drawn By: KLW


Drawing No.:

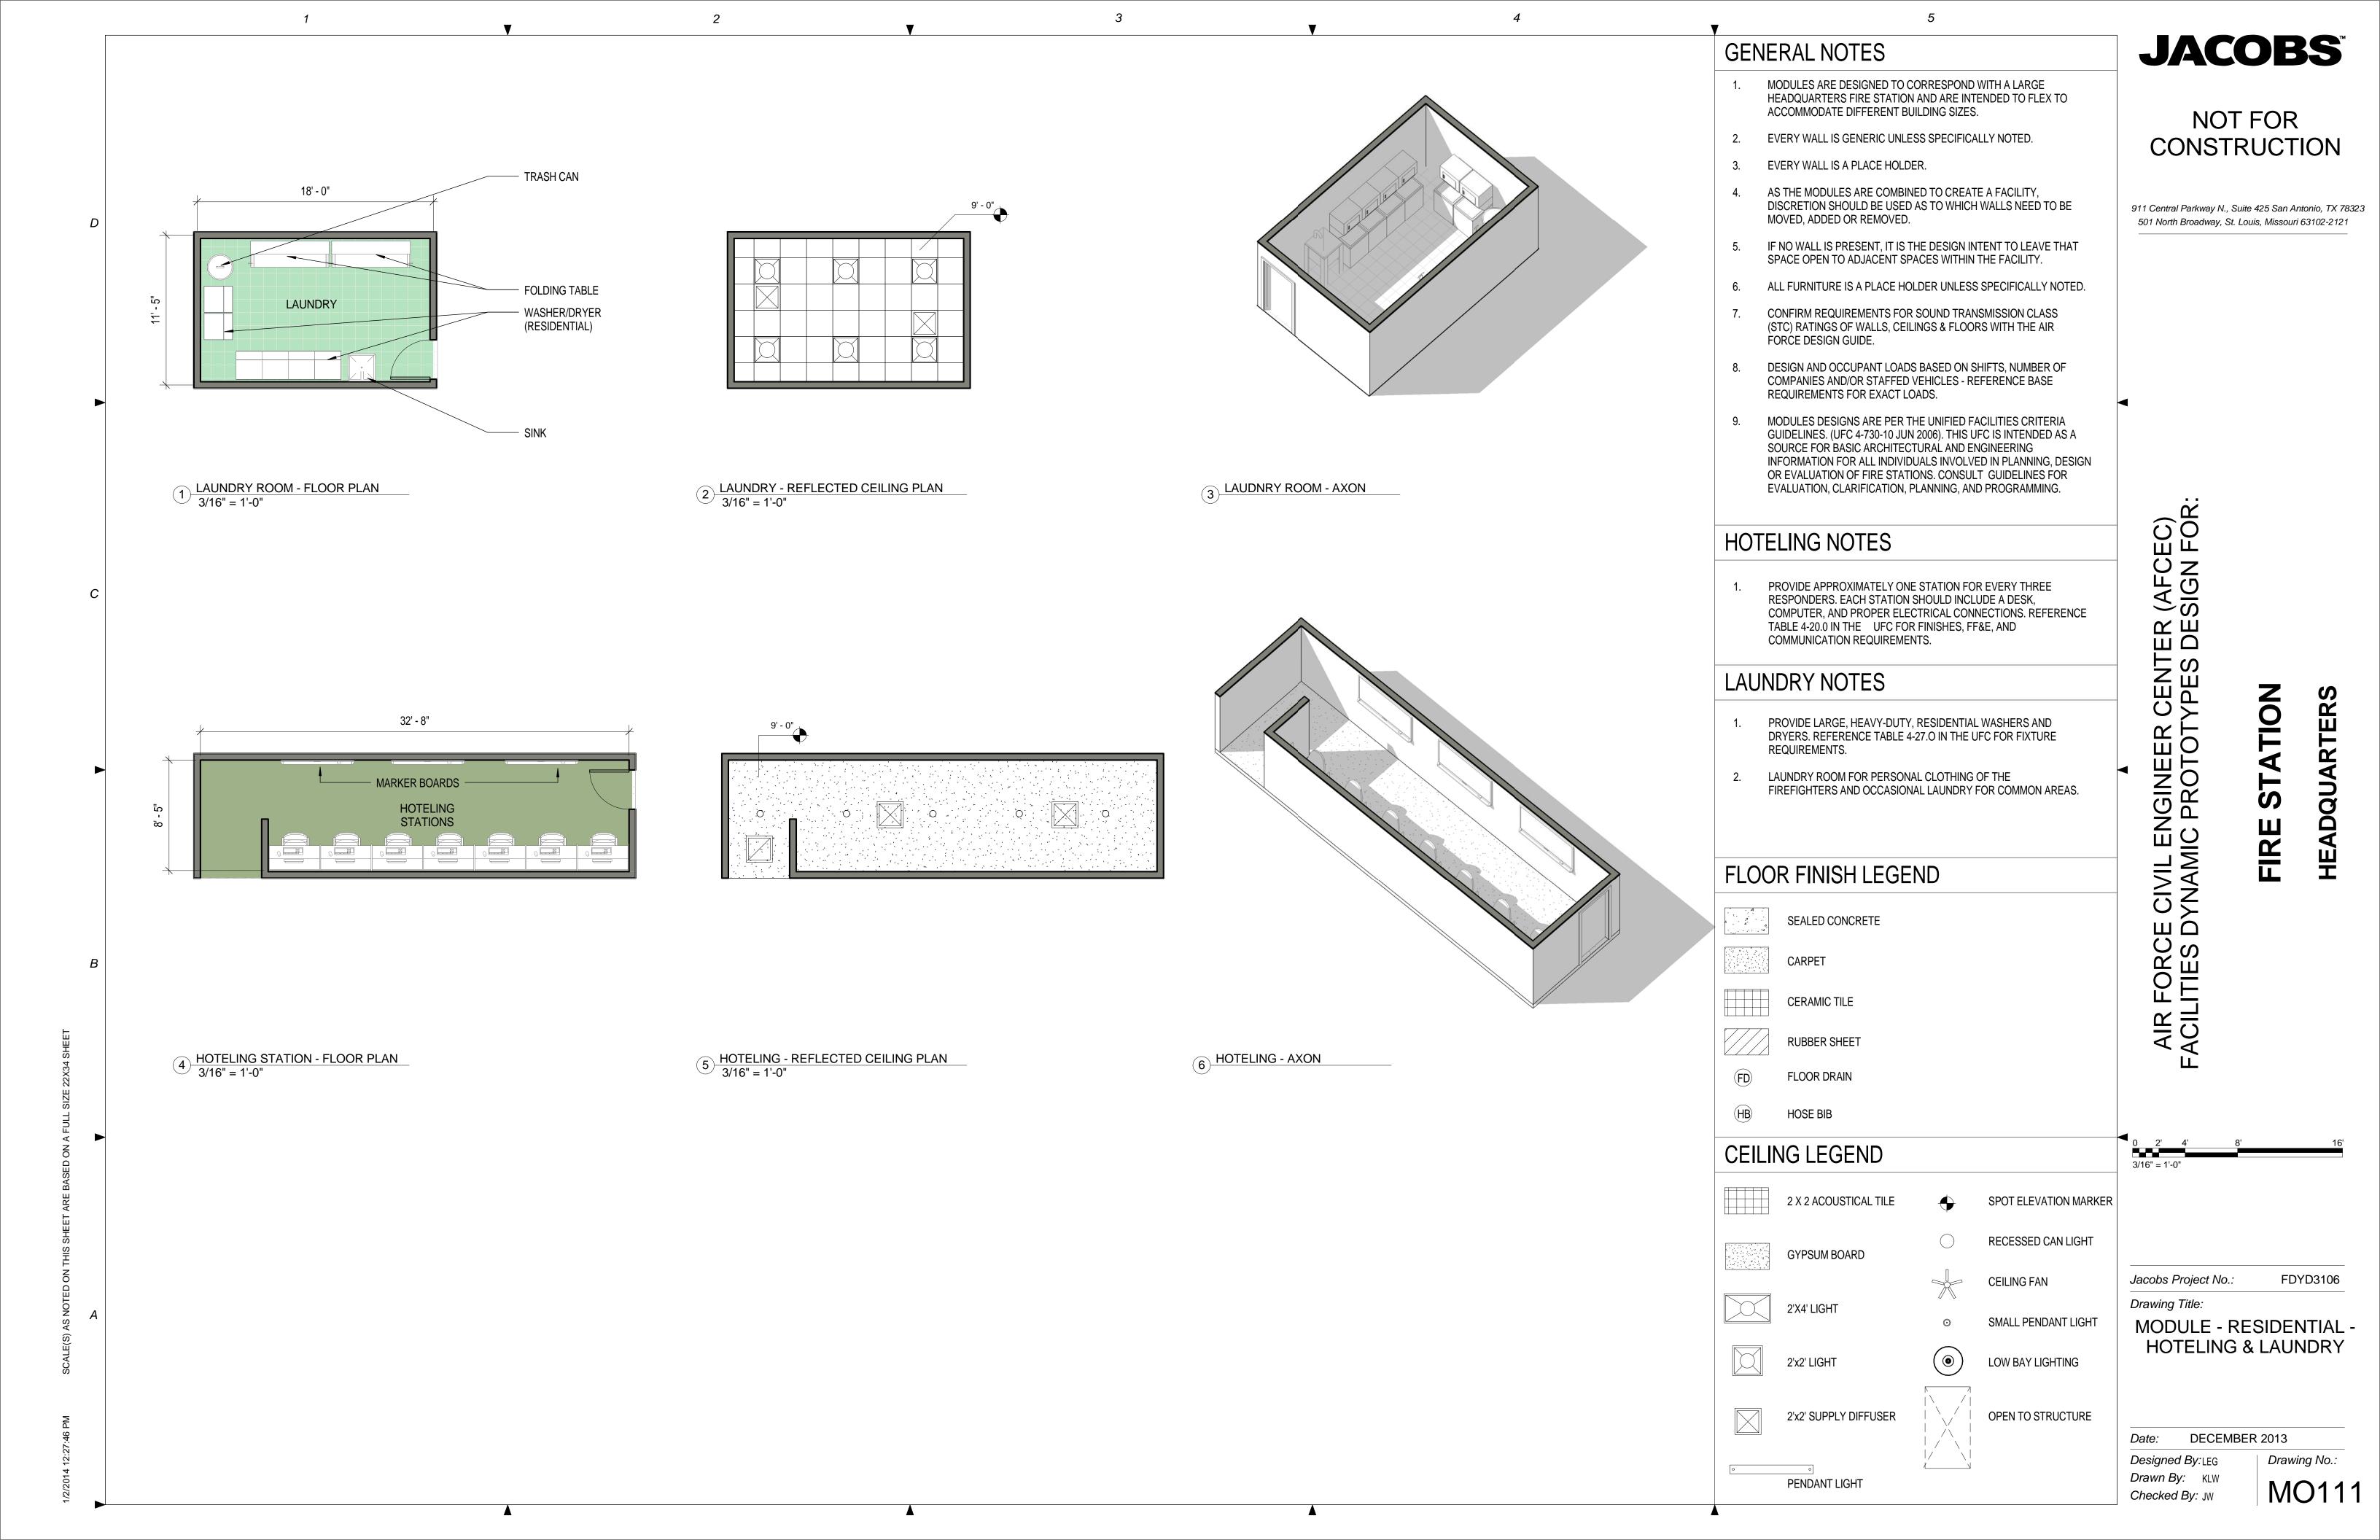

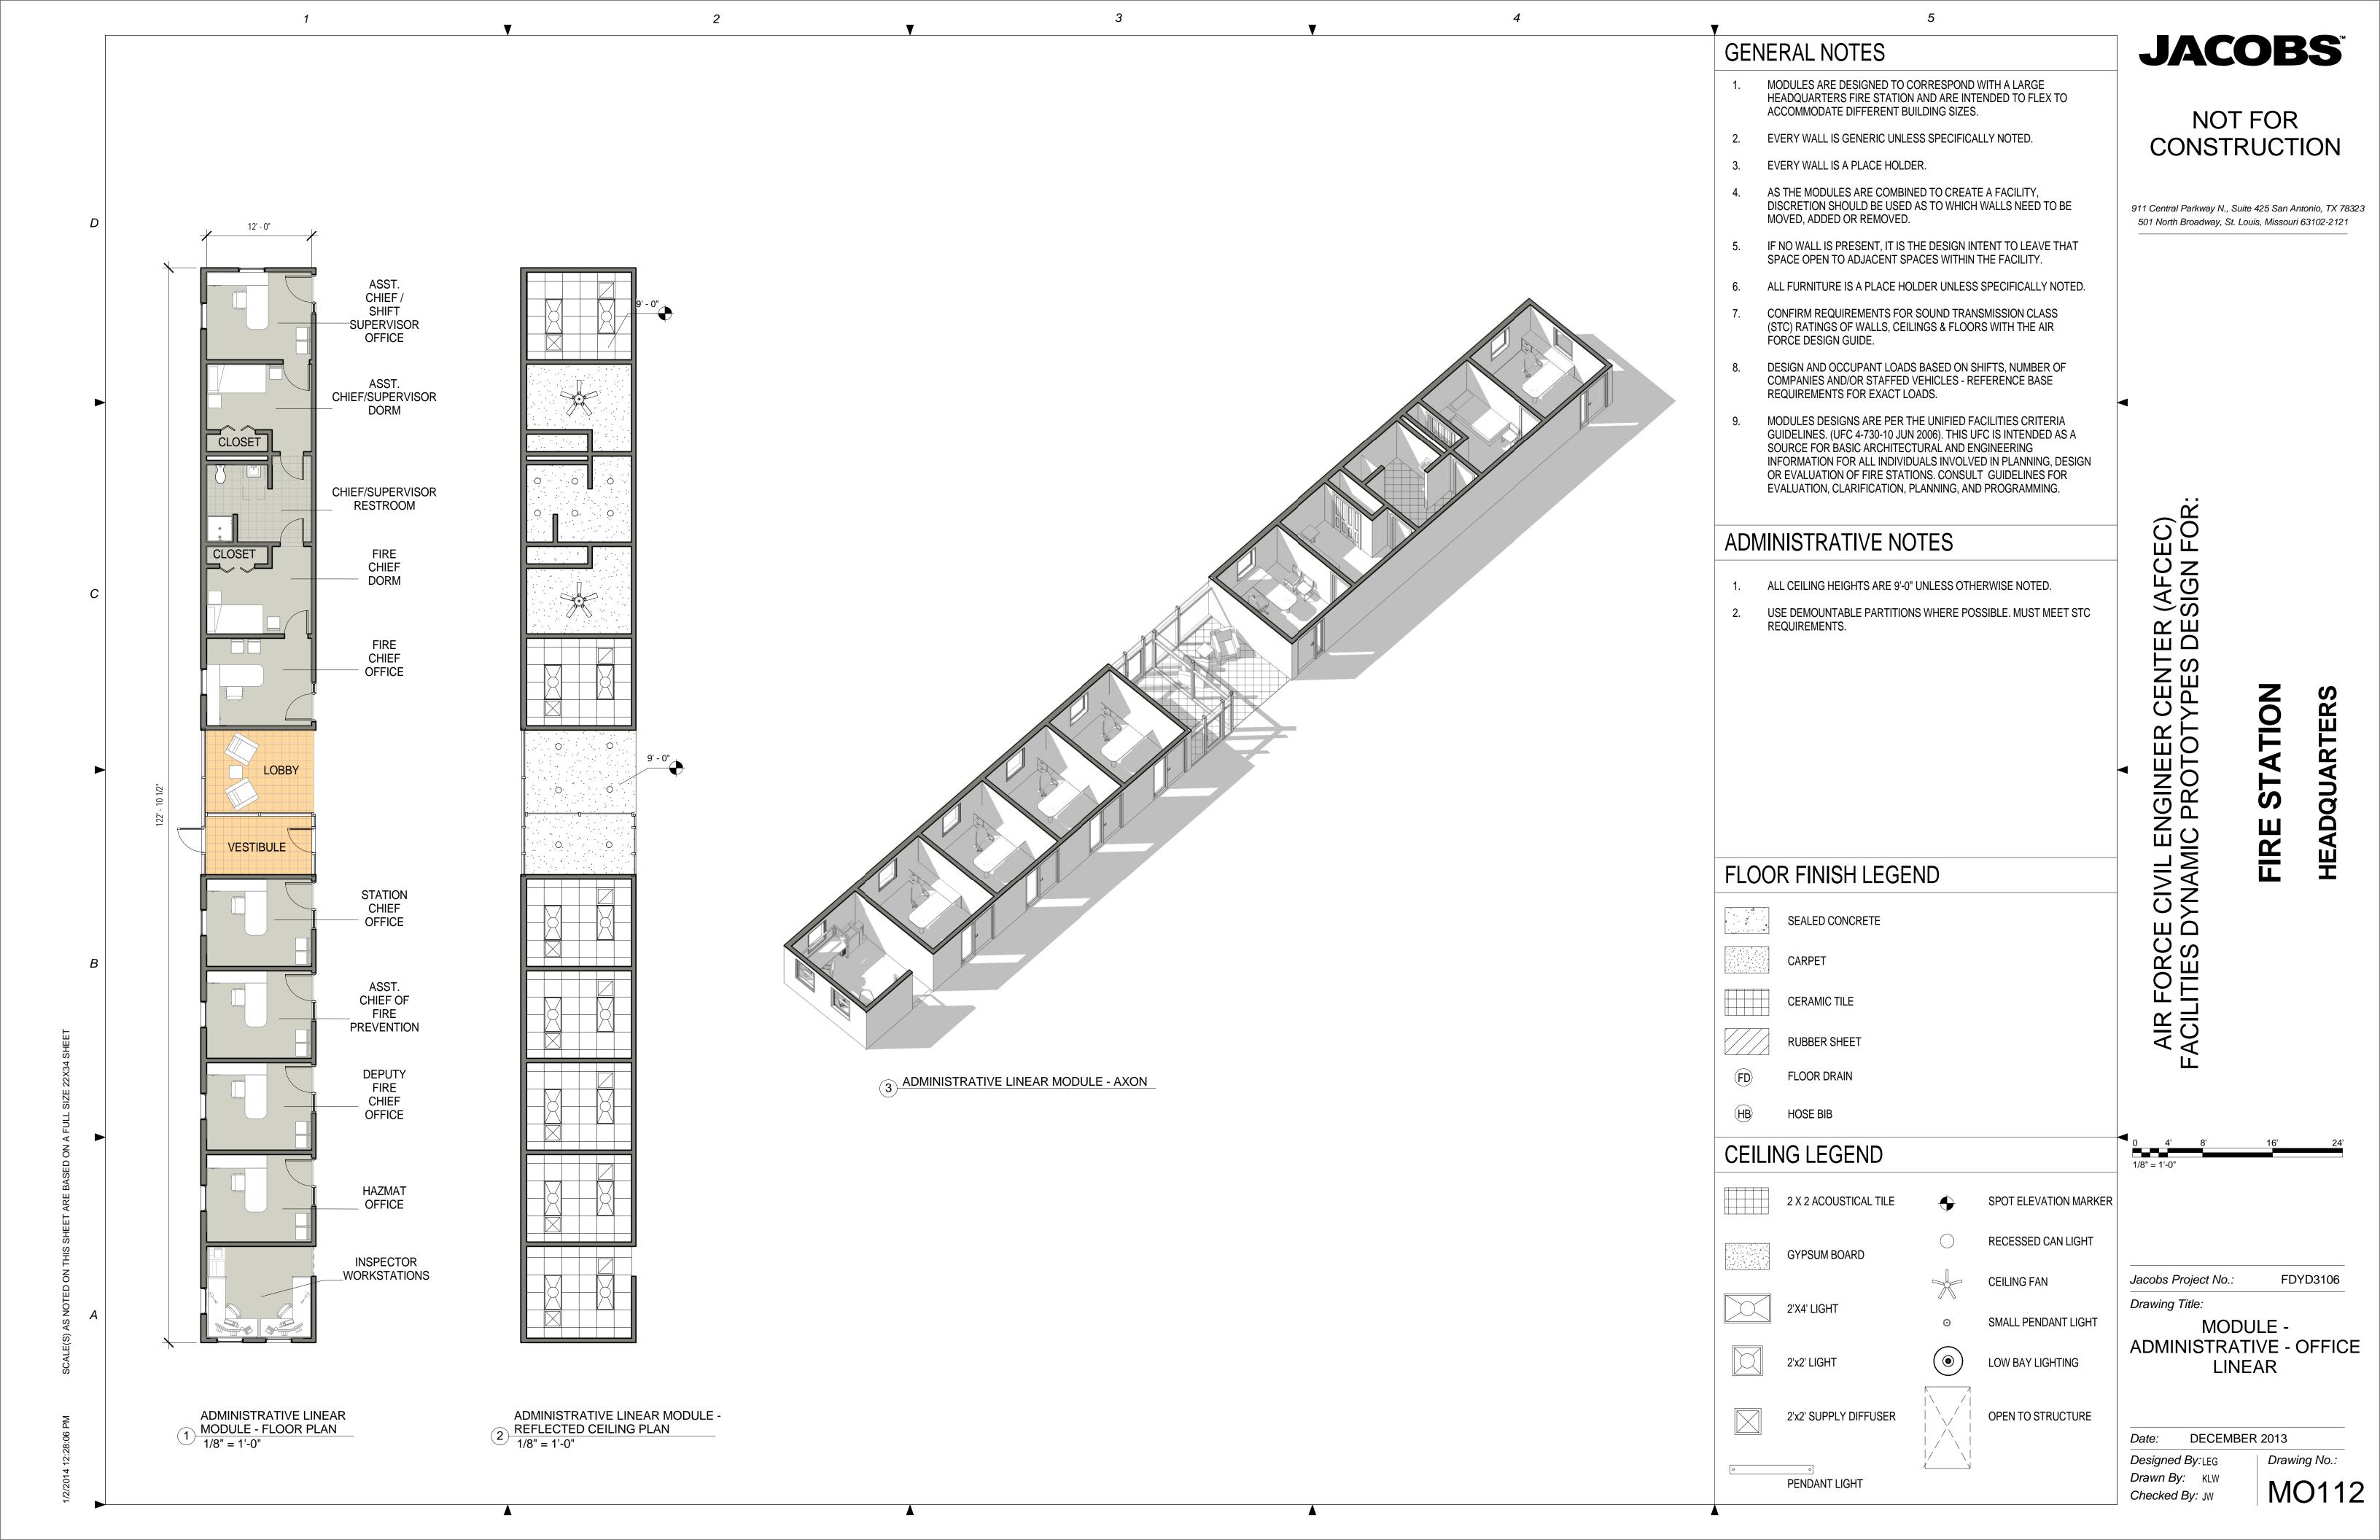



CHIEF OFFICE

OFFICES SUITE MODULE - FLOOR PLAN 1/8" = 1'-0"

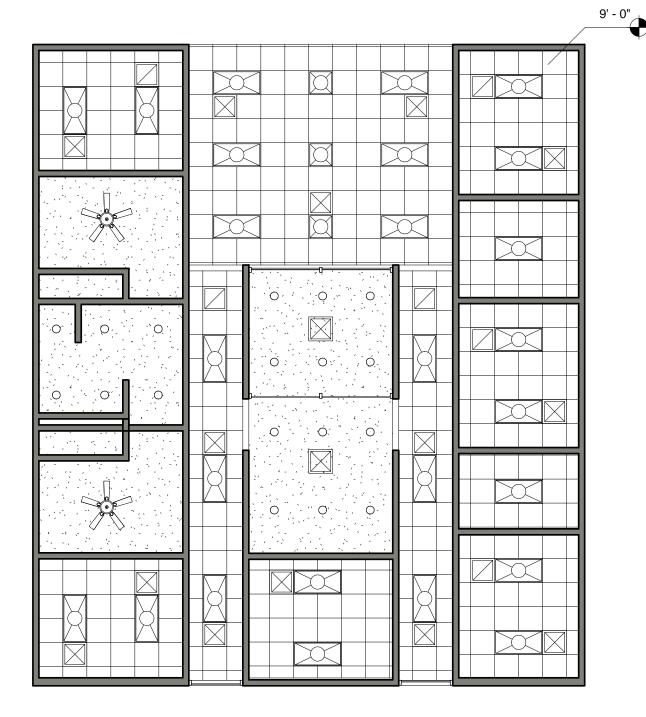

OFFICES SUITE MODULE - REFLECTED CEILING PLAN
1/8" = 1'-0"

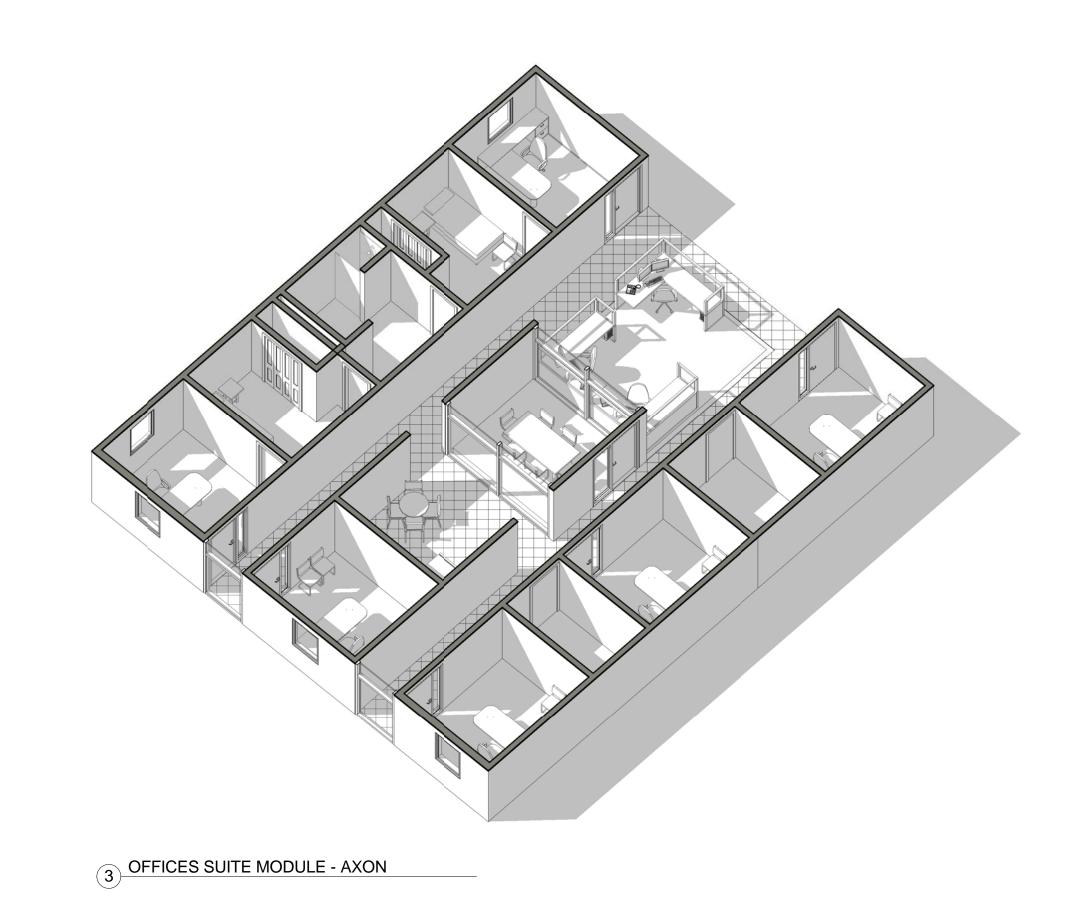

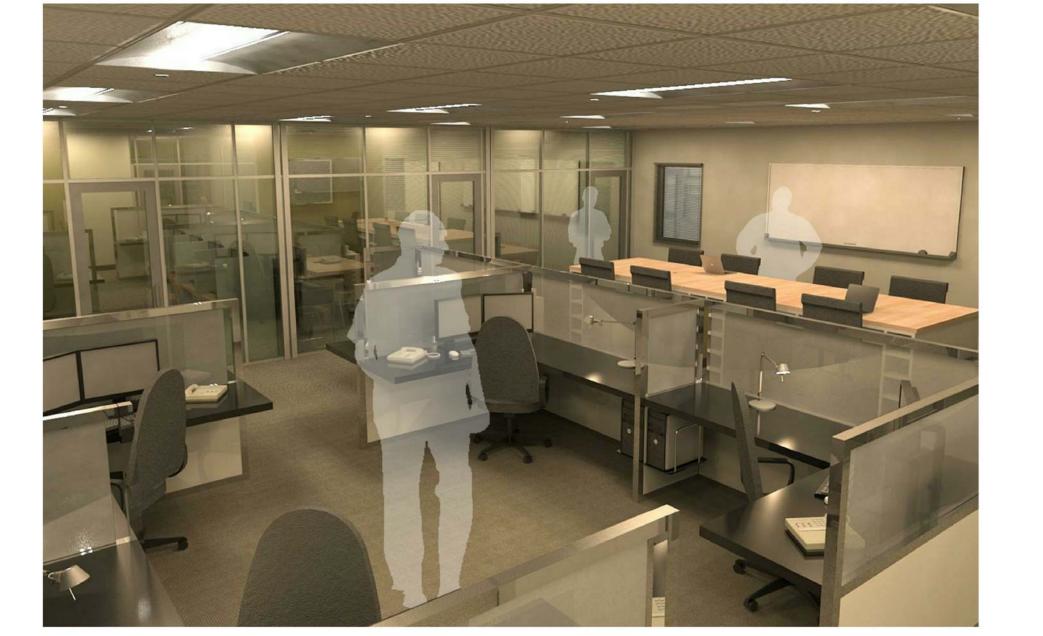

OFFICE SUITE

GENERAL NOTES

- MODULES ARE DESIGNED TO CORRESPOND WITH A LARGE HEADQUARTERS FIRE STATION AND ARE INTENDED TO FLEX TO ACCOMMODATE DIFFERENT BUILDING SIZES.
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ADMINISTRATIVE NOTES

- ALL CEILING HEIGHTS ARE 9'-0" UNLESS OTHERWISE NOTED.
- USE DEMOUNTABLE PARTITIONS WHERE POSSIBLE. MUST MEET STC REQUIREMENTS.

FLOOR FINISH LEGEND

SEALED CONCRETE

CERAMIC TILE

RUBBER SHEET

FLOOR DRAIN

HOSE BIB

CEILING LEGEND

2 X 2 ACOUSTICAL TILE

2'X4' LIGHT

SPOT ELEVATION MARKER

CEILING FAN

GYPSUM BOARD

RECESSED CAN LIGHT

SMALL PENDANT LIGHT




2'x2' SUPPLY DIFFUSER

PENDANT LIGHT



LOW BAY LIGHTING

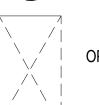

OPEN TO STRUCTURE

DECEMBER 2013

Jacobs Project No.:

Drawing Title:

Designed By: LEG Drawing No.: Drawn By: KLW

MO113 Checked By: JW

MODULE -

ADMINISTRATIVE - OFFICE

SUITE

FDYD3106

JACOBS

NOT FOR

CONSTRUCTION

911 Central Parkway N., Suite 425 San Antonio, TX 78323

501 North Broadway, St. Louis, Missouri 63102-2121

FER (AFCEC) DESIGN FOR:


IL ENGINEER CENT MIC PROTOTYPES

AIR FORCE CIVII FACILITIES DYNAN


ATION

ARTERS


1 TRAINING MODULE - FLOOR PLAN 1/8" = 1'-0"

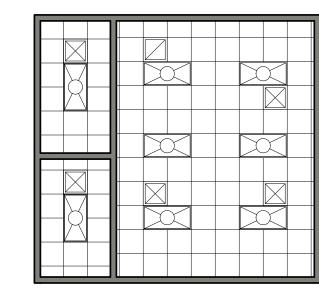


TRAINING MODULE -2 REFLECTED CEILING PLAN
1/8" – 1' 0" 1/8" = 1'-0"

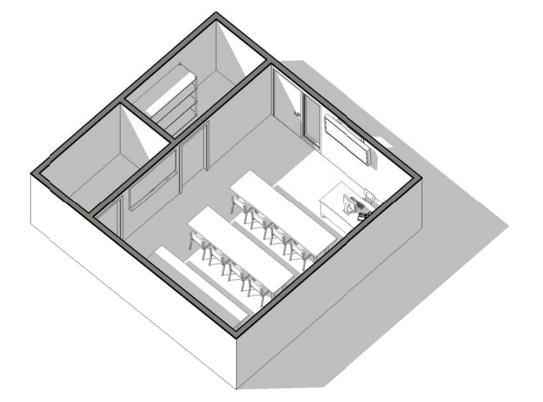


3 TRAINING MODULE - AXON

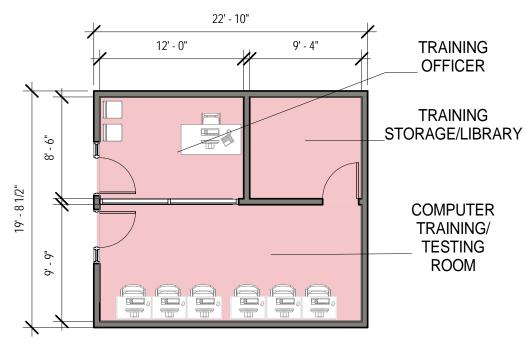


TESTING MODULE - FLOOR PLAN
1/8" = 1'-0"

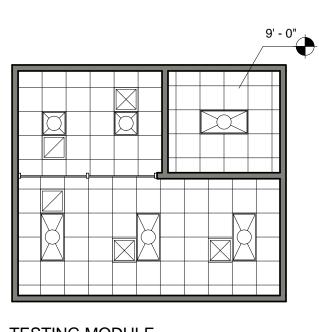


TESTING MODULE -5 REFLECTED CEILING PLAN
1/8" = 1'-0"

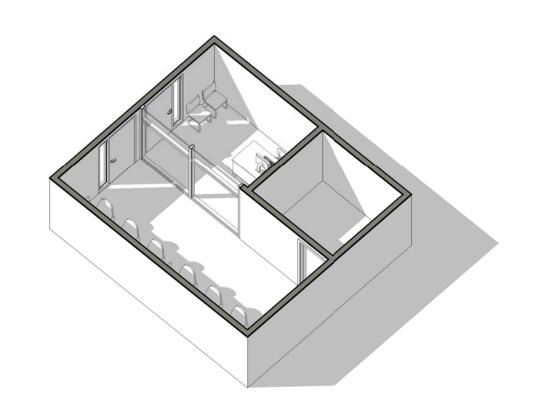

6 TESTING MODULE - AXON

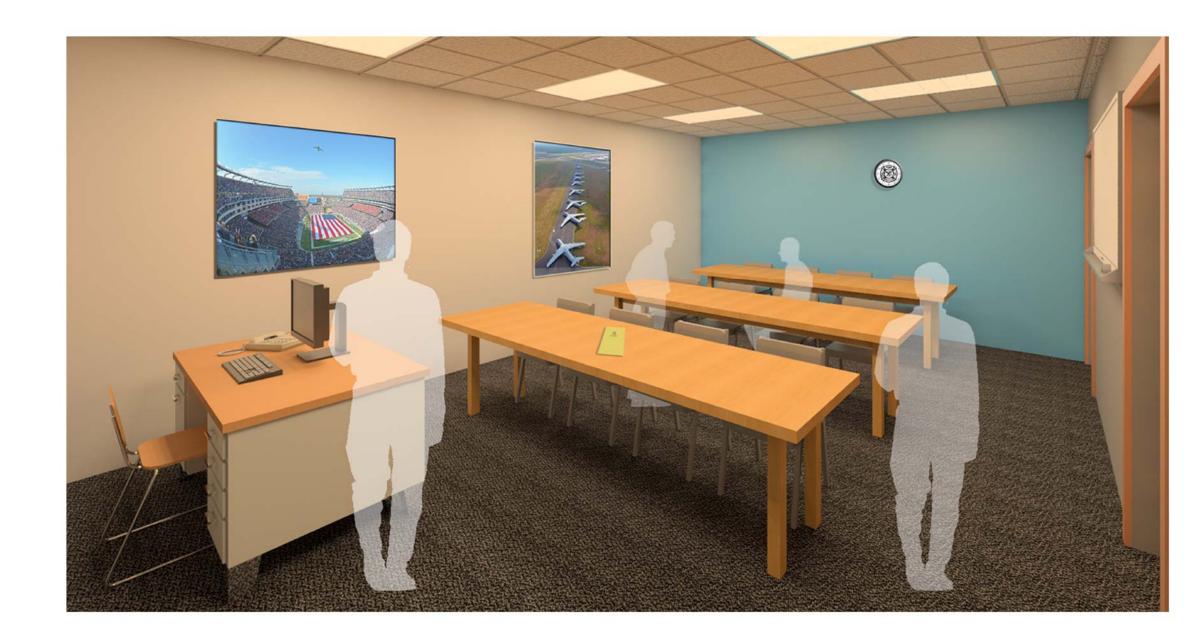

DEPARTMENT TRAINING ROOM

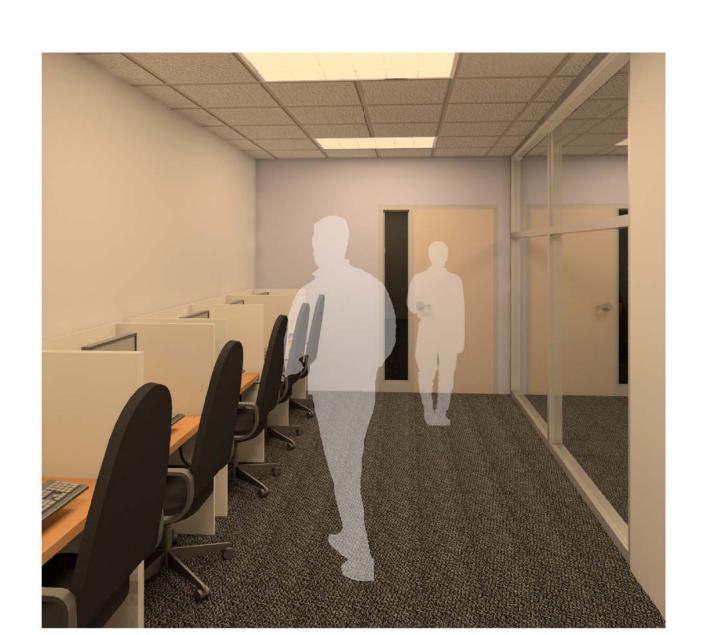

COMPUTER TESTING ROOM

GENERAL NOTES

- MODULES ARE DESIGNED TO CORRESPOND WITH A LARGE HEADQUARTERS FIRE STATION AND ARE INTENDED TO FLEX TO ACCOMMODATE DIFFERENT BUILDING SIZES.
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TRAINING/TESTING NOTES

- TRAINING ROOM IS SIZED TO ACCOMMODATE THE ENTIRE ON-DUTY POPULATION. USED FOR EDUCATION AND TRAINING OF PERSONNEL AND OCCASIONALLY PUBLIC. SHOULD HAVE DIRECT ACCESS TO A IT ROOM AND STORAGE SPACE.
- IN THE TESTING ROOM PROVIDE STUDY/ COMPUTER CAROLS PER THE UFC.

FLOOR FINISH LEGEND

SEALED CONCRETE

CERAMIC TILE

RUBBER SHEET

FLOOR DRAIN

HOSE BIB

CEILING LEGEND

2 X 2 ACOUSTICAL TILE

SPOT ELEVATION MARKER

CEILING FAN



RECESSED CAN LIGHT



SMALL PENDANT LIGHT



2'x2' SUPPLY DIFFUSER

2'X4' LIGHT

GYPSUM BOARD



LOW BAY LIGHTING



OPEN TO STRUCTURE

DECEMBER 2013 Drawing No.: Checked By: JW

MODULE -

ADMINISTRATIVE -

TRAINING & TESTING

JACOBS

NOT FOR

CONSTRUCTION

911 Central Parkway N., Suite 425 San Antonio, TX 78323

501 North Broadway, St. Louis, Missouri 63102-2121

FER (AFCEC) DESIGN FOR:

AIR FORCE CIVII FACILITIES DYNAN

MOL

ARTER

PENDANT LIGHT

Designed By: LEG Drawn By: KLW

Jacobs Project No.:

Drawing Title:

MO114



1 LOGISTICS - FLOOR PLAN 1/8" = 1'-0"


DISPATCH

STATION


4 DISPATCH (ECC)- FLOOR PLAN 1/8" = 1'-0"

28' - 0"

2 LOGISTICS - REFLECTED CEILING PLAN
1/8" = 1'-0"

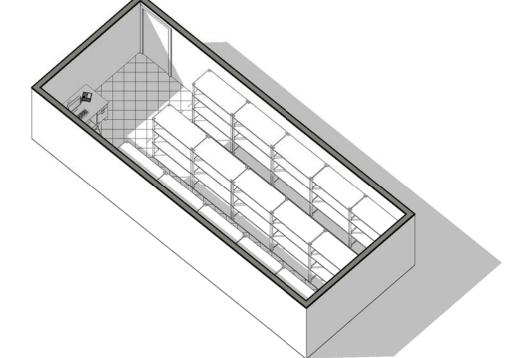


(3) LOGISTICS - AXON

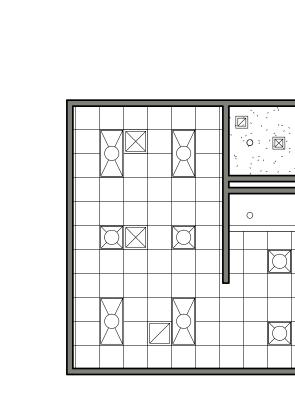

DISPATCH (ECC)

5 DISPATCH (ECC) - REFLECTED CEILING PLAN
1/8" = 1'-0"

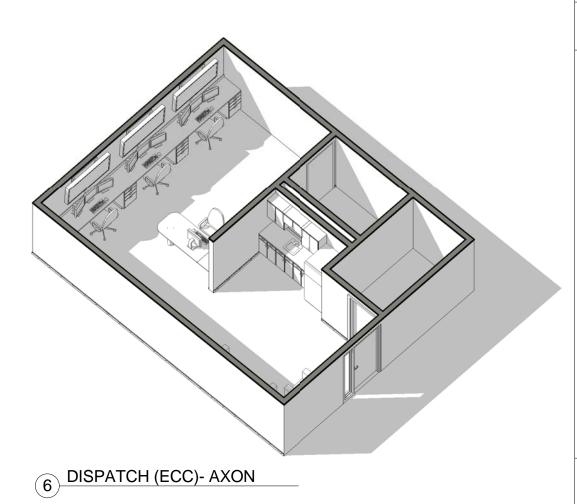

- MODULES ARE DESIGNED TO CORRESPOND WITH A LARGE HEADQUARTERS FIRE STATION AND ARE INTENDED TO FLEX TO
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DISPATCH NOTES

- DISPATCH ROOM INCLUDES DEDICATED RESTROOM, KITCHENETTE, AND IT ROOM.
- PROVIDE VISIBLE ACCESS TO EXTERIOR AND ALSO THE FLIGHTLINE WHEN APPLICABLE.

FLOOR FINISH LEGEND

SEALED CONCRETE

CERAMIC TILE

RUBBER SHEET

FLOOR DRAIN

CEILING LEGEND

HOSE BIB

2 X 2 ACOUSTICAL TILE

GYPSUM BOARD

2'X4' LIGHT

2'x2' LIGHT

2'x2' SUPPLY DIFFUSER

PENDANT LIGHT

SPOT ELEVATION MARKER

RECESSED CAN LIGHT

CEILING FAN

SMALL PENDANT LIGHT

LOW BAY LIGHTING

LOGISTICS & DISPATCH OPEN TO STRUCTURE

DECEMBER 2013

Jacobs Project No.:

Drawing Title:

Designed By: LEG Drawing No.: Drawn By: KLW MO115 Checked By: JW

MODULE -ADMINISTRATIVE -

FDYD3106

JACOBS

NOT FOR

CONSTRUCTION

911 Central Parkway N., Suite 425 San Antonio, TX 78323

501 North Broadway, St. Louis, Missouri 63102-2121

FER (AFCEC) DESIGN FOR:

AIR FORCE CIVIL ENGINEER FACILITIES DYNAMIC PROTOT

NOL



JACOBS

NOT FOR CONSTRUCTION

911 Central Parkway N., Suite 425 San Antonio, TX 78323 501 North Broadway, St. Louis, Missouri 63102-2121

CENTER (AFCEC) YPES DESIGN FOR

MOL

ARTERS

LOBBY NOTES

LOCATE LOBBY ADJACENT TO ADMINISTRATIVE COMPONENT. PROVIDE UPHOLSTERED SEATING AND SIDE TABLES.

MODULES ARE DESIGNED TO CORRESPOND WITH A LARGE HEADQUARTERS FIRE STATION AND ARE INTENDED TO FLEX TO

EVERY WALL IS GENERIC UNLESS SPECIFICALLY NOTED.

AS THE MODULES ARE COMBINED TO CREATE A FACILITY,

DISCRETION SHOULD BE USED AS TO WHICH WALLS NEED TO BE

IF NO WALL IS PRESENT, IT IS THE DESIGN INTENT TO LEAVE THAT SPACE OPEN TO ADJACENT SPACES WITHIN THE FACILITY.

ALL FURNITURE IS A PLACE HOLDER UNLESS SPECIFICALLY NOTED.

CONFIRM REQUIREMENTS FOR SOUND TRANSMISSION CLASS (STC) RATINGS OF WALLS, CEILINGS & FLOORS WITH THE AIR

DESIGN AND OCCUPANT LOADS BASED ON SHIFTS, NUMBER OF COMPANIES AND/OR STAFFED VEHICLES - REFERENCE BASE

MODULES DESIGNS ARE PER THE UNIFIED FACILITIES CRITERIA GUIDELINES. (UFC 4-730-10 JUN 2006). THIS UFC IS INTENDED AS A

INFORMATION FOR ALL INDIVIDUALS INVOLVED IN PLANNING, DESIGN OR EVALUATION OF FIRE STATIONS. CONSULT GUIDELINES FOR EVALUATION, CLARIFICATION, PLANNING, AND PROGRAMMING.

SOURCE FOR BASIC ARCHITECTURAL AND ENGINEERING

ACCOMMODATE DIFFERENT BUILDING SIZES.

EVERY WALL IS A PLACE HOLDER.

MOVED, ADDED OR REMOVED.

FORCE DESIGN GUIDE.

REQUIREMENTS FOR EXACT LOADS.

PROVIDE WALK-OFF MAT AT ENTRANCE. ENTRANCE SHOULD BE AN AIRLOCK.

FLOOR FINISH LEGEND

SEALED CONCRETE

CERAMIC TILE

RUBBER SHEET

FLOOR DRAIN

HOSE BIB

CEILING LEGEND

2 X 2 ACOUSTICAL TILE

GYPSUM BOARD

2'X4' LIGHT

SPOT ELEVATION MARKER



RECESSED CAN LIGHT




SMALL PENDANT LIGHT



2'x2' SUPPLY DIFFUSER

PENDANT LIGHT

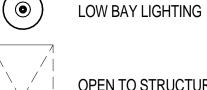



OPEN TO STRUCTURE

Jacobs Project No.:

Drawing Title:

DECEMBER 2013

Drawing No.: Designed By: LEG Drawn By: KLW Checked By: JW

MODULE -

ADMINISTRATIVE -

RESERVE, LOBBY, BREAK

RM

MO116

Prototype Fire Station - HQ/Main Combination - Composite A

2 Structural, 4 ARFF Companies with 20 Responders

1/2/2014 11:44:43 AM

AINTENANCE & APPARATUS AREA Apparatus Bay 1,471.5 15,840 16,656 Small Vehicle (two per bay, if needed) Apparatus Bays Medium Structural Large Structural Medium ARFF Large ARFF EMS Storage - Closet Equipment Wash / Disinfection -0.7% Fire Extinguisher Inspection 12.5% Flightline Fire Extinguishing Maintenance and Storage 8.8% Flightline Fire Extinguishing Tank Recovery Exterior Covered Storage HAZMAT / CBRN Equipment Storage Calculated at half area 0.0% 4.0% Hose Storage Apparatus Infectious Control PPE Gear Storage Protective Clothing Laundry SCBA Compressor Room 1.0% SCBA Maintenance Room Spare Flightline Fire Extinguishing Tank Exterior Covered Storage 0.0% Calculated at half area Spare PPE Gear Storage Work Room / Equipment Maintenance 11.1 120.0 Agent Storage (ARFF)
Agent Storage (Structural) 41.8 450.0 48.0 SUBTOTAL MAINTENANCE & APPARATUS AREA 1,640.6 17,660 18,613 5.4% 953 DAY ROOM & RESIDENTIAL AREA 223.0 Combination of dining, kitchen, and living Day Room 26.0 16.3 280 175 276 Hoteling Stations -1.4% One workstation for every three Responders 28.6% ilculated at half area Dorm Rooms | Dorm Rooms Bathrooms / Showers / Changing - Female Responders Lavatories Water Closets Bathrooms / Showers / Changing - Male Responders Lavatories Water Closets / Urinals Water Closet(s), (2) Urinal(s) Laundry Laundry Room Fitness Room 111.5 -19.8% Recreation Recreation Room 33.4 363 3 0.8% SUBTOTAL DAY ROOM & RESIDENTIAL AREA 693.5 7,465 7,567 102 1.4% RAINING & ADMINISTRATIVE AREA Main Entry Vestibule Admin & Training Restrooms 27.1 0.0% 292 Female Lavatories Female Water Closets Male Lavatories Male Water Closets / Urinals 1) ABA Water Closet, (1) Water Closet(s), (1) Urinal(s) -27.0% Administration & Training Break Room Administration Assistant Assistant Chief / Shift Supervisor Asst. Chief of Operations 0.0% Assistant Chief of Fire Prevention Assistant Chief of Operations / Shift Supervisor's Dorm Room 20.0% Hard wall closet construction optional. Chief's / Supervisor's Bathroom (1) Lavatory, (1) Shower, (1) Water Closet Chief's Conference Room Deputy Chief's Office EMS Office 75.0% Shown as hard wall office Fire Chief's Dorm Room Hard wall closet construction optional. Fire Chief's Office General Administration Storage 0.0% HAZMAT / Safety Office 0.0% Inspector's Office(s) / Workstation(s) Station Chief Office / Watch Desk -2.5% Station Chief / Station Capt. Union Representative - Office 1.0% Computer Training / Testing Room -2.4% Asst. Chief of Training Training and Training Officer Office Training Room 76.3% Training Room Storage Logistics Office Logistics Storage Air Force Reserve and Active Duty Mobility / Deployment Gear Stor. Air Force Reserve Firefighter PPE Gear 10 SF / Reservist 22.3 -2.5% Air Force Reserve Supervisor -4.2% Air Force Reserve Workstations 9.4% SUBTOTAL TRAINING & ADMINSTRATIVE AREA 393.3 4,234 4,308 EMERGENCY CONTROL CENTER (ECC) ECC Dispatcher ECC IT Room ECC Kitchenette ECC Restroom SUBTOTAL E.C.C. AREA FIRE STATION NET ASSIGNED FLOOR AREA 2,781.0 29,935 31,063 1,128 3.8% INFRASTRUCTURE Facility Maint. Janitor 14.0 -54 -35.6% 1/2% of Net Assigned Area Electrical Rooms -41.8% 2% of Net Assigned Area Mechanical / 24.5 Mechanical Room - Admin Area Based upon Conditioned Area Electrical Based upon Conditioned Area Mechanical Room - Responders Area -32.6% Base IT / Comms Room (s) Telecomm / IT Based on number of Structural and/or ARFF Cos. 32,467 822 2.6% FIRE STATION NET FUNCTIONAL AREA 2,939.8 31,645 NON-FUNCTION SPACE Circulation | Corridors, Halls, and other Interior Circulation 2,449 -2,041 -45.5% Entries | Covered Exterior Entries 0.0% Calculated at half area 222.5 1,085 8% of Net Assigned Area -12.0% SUBTOTAL NON-FUNCTION AREA 639.6 6,885 -827 TOTAL FIRE STATION GROSS AREA 3,579.4 38,530 38,525 -5 0.0% FIRE STATION DESIGN EFFICIENCY 78% 81%

AS DESIGNED
SF Delta (SF) Delta (%)

COMMENTS





HEADQUARTERS COMBINATION ENTRY PERSPECTIVE



HEADQUARTERS COMBINATION BUILDING PERSPECTIVE

JACOBS

NOT FOR CONSTRUCTION

911 Central Parkway N., Suite 425 San Antonio, TX 78323 501 North Broadway, St. Louis, Missouri 63102-2121

AIR FORCE CIVIL ENGINEER CENTER (AFCEC) FACILITIES DYNAMIC PROTOTYPES DESIGN FOR

ATION

JARTER

Jacobs Project No.:

FDYD3106


Drawing Title:

COMPOSITE A - LARGE
HEADQUARTERS
COMBINATION PROGRAM
AND PERSPECTIVES

Date: DECEMBER 2013

Designed By:LEG
Drawn By: KLW
Checked By: JW

Drawing No.:
CO101

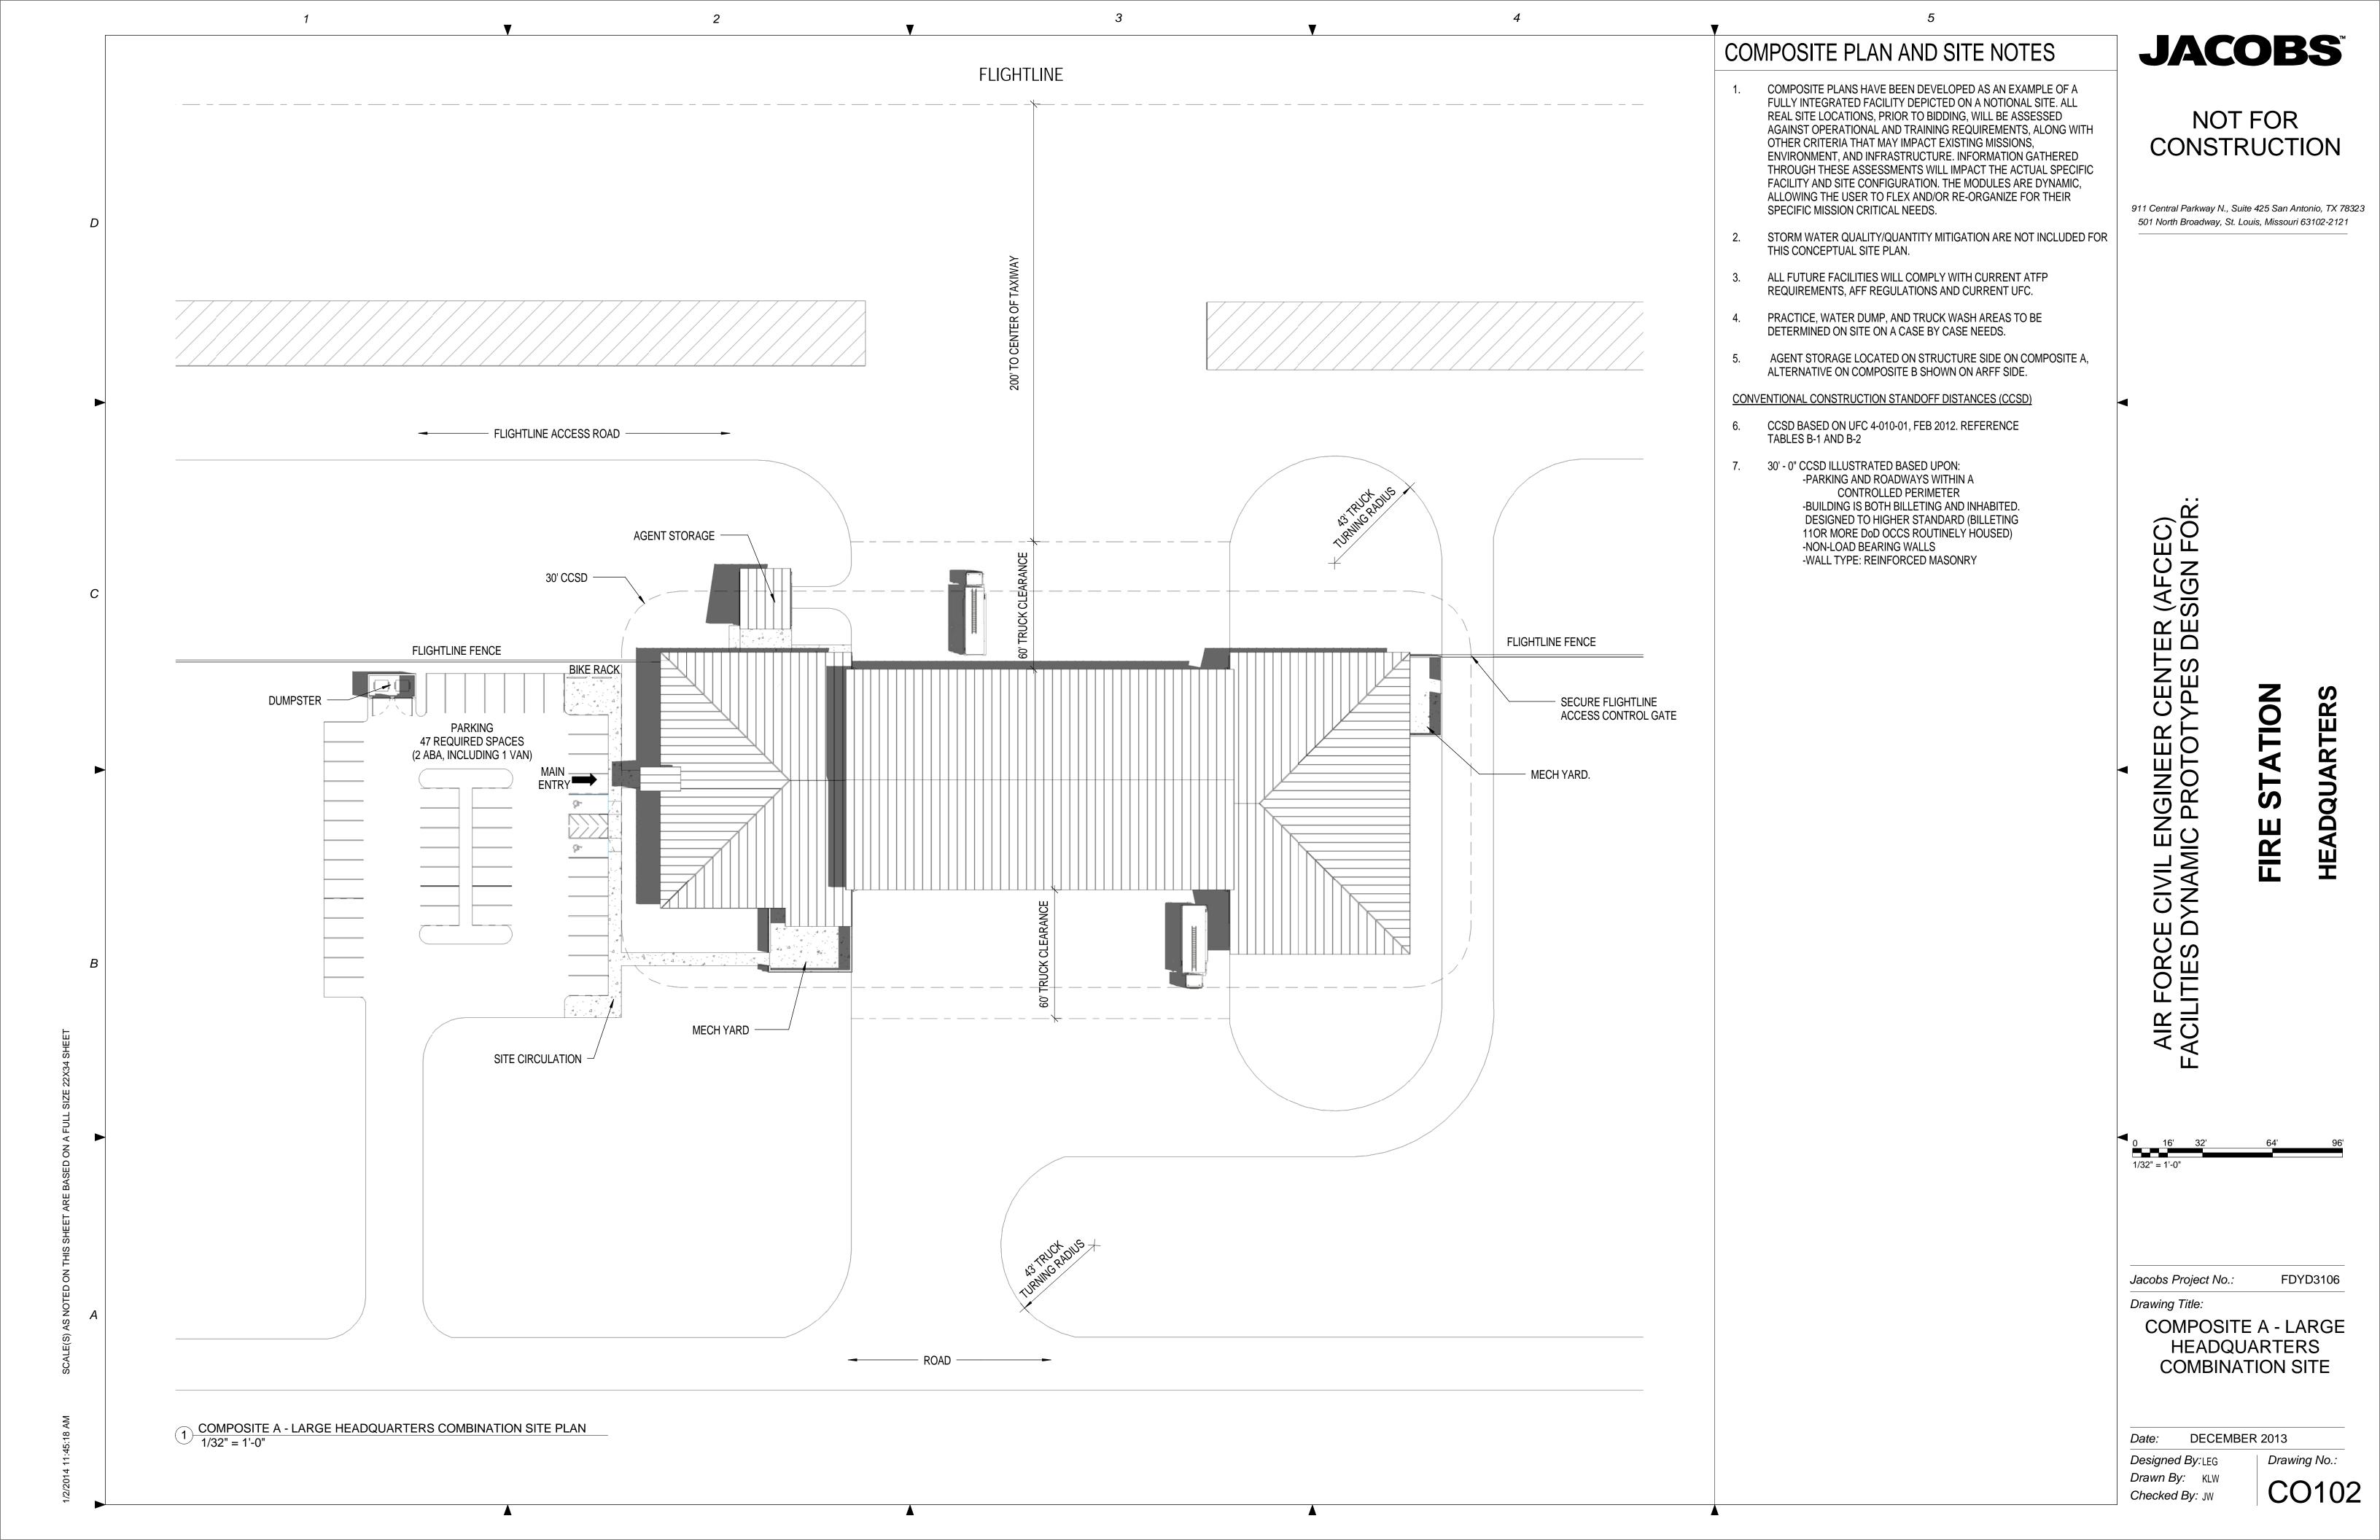

DISPATCH

(ECC)

LOGISTICS

BREAK

ROOM

HOTELING

RECREATION

RESERVE

TESTING

ADMINISTRATION

TRAINING

JACOBS

NOT FOR CONSTRUCTION

911 Central Parkway N., Suite 425 San Antonio, TX 78323 501 North Broadway, St. Louis, Missouri 63102-2121

FDYD3106


COMPOSITE A - LARGE HEADQUARTERS **COMBINATION OVERALL** FLOOR PLAN

DECEMBER 2013 Date:

Designed By:LEG Drawn By: KLW Checked By: JW

Drawing No.: CO103



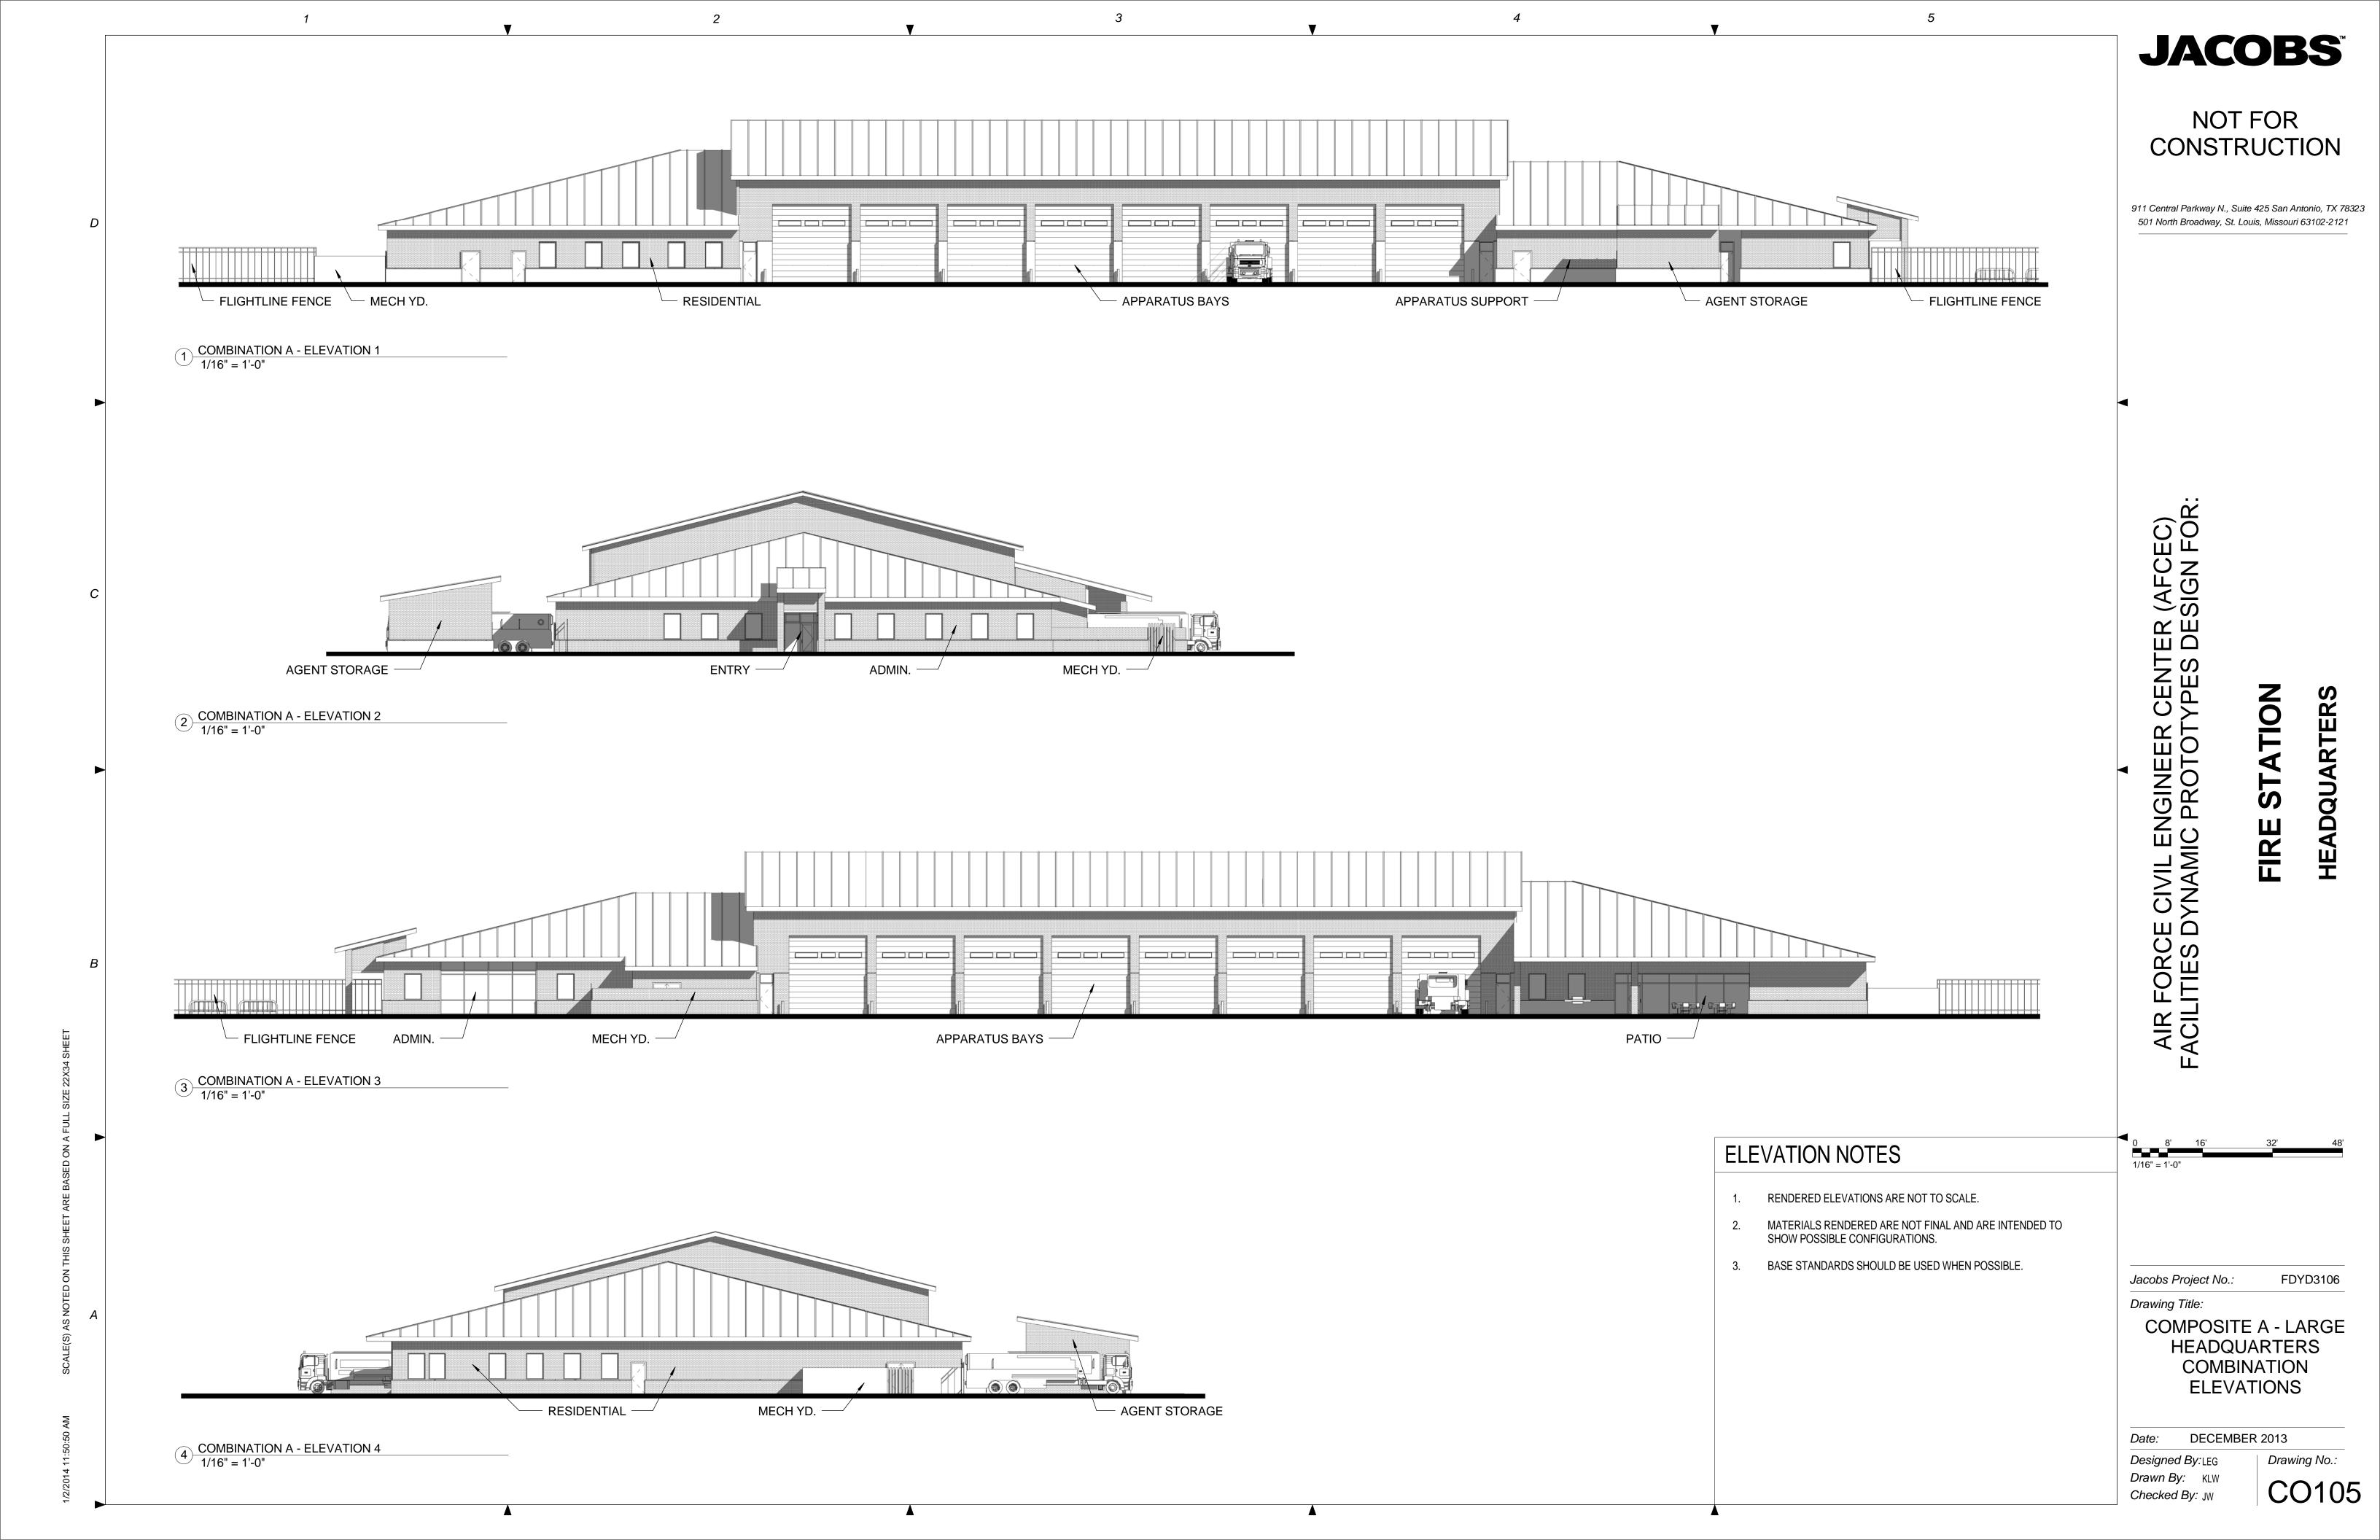

Walls Interior Partitions and W


TOT:

FIRE

PREDESIGN AREA MATRIX

	Prototype Fire Station HQ/Main Combination - Composite B						
2 Struc	ctural, 4 ARFF Companies with 20 Responders	177767667676	EMENTS				COMMENTS
Modules		UFC Planning Ter	mplate (Nov 2011) SF	SF	AS DESIGNED Delta (SF)	Delta (%)	COMMENTS
AINTENANC	CE & APPARATUS AREA						
	Apparatus Bay Small Vehicle (two per bay, if needed)	1,471.5	15,840	15,946	106	0.7%	
Apparatus	Medium Structural	7					
Bays	Large Structural Medium ARFF	6					
	Large ARFF	0	40	10		7.504	HE THE TREE THE AVENUE AND THE
	EMS Storage - Closet Equipment Wash / Disinfection	3.7 13.9	40 150	43 154	3	7.5% 2.7%	
	Fire Extinguisher Inspection	4.5	48	43	-5	-10.4%	
	Flightline Fire Extinguishing Maintenance and Storage HAZMAT / CBRN Equipment Storage	14.9 11.1	160 120	175 131	15 11	9.4% 9.2%	
Apparatus	Hose Storage	5.0	54	58	4	7.4%	
Support	Infectious Control PPE Gear Storage	14.9 18.6	160 200	173 208	13 8	8.1% 4.0%	
	Protective Clothing Laundry	27.9	300	308	8	2.7%	
	SCBA Compressor Room SCBA Maintenance Room	9.3 27.9	100 300	106 325	6 25	6.0% 8.3%	
	Spare PPE Gear Storage	5.9	64	65	1	1.6%	
A t Ot	Work Room / Equipment Maintenance Agent Storage (ARFF)	11.1 41.8	120.0 450.0	128 450	0	0	
Agent Storage	Agent Storage (Structural) SUBTOTAL MAINTENANCE. & APPARATUS AREA	4.5	48.0	48	0 207	0	
AV BOOM 8	TO A CAMPACT COLOR FOR THE COLOR OF THE COLO	1,640.2	17,656	17,863	207	1.2%	
AT ROUNT &	RESIDENTIAL AREA Day Room	223.0	2,400	2,428	28	1.2%	Combination of dining, kitchen, and living
Day	Hoteling Stations	26.0	280	287	7	2.5%	One workstation for every three Responders
Dorm Rooms	Patio Dorm Rooms	16.3 200.7	175 2,160	178 2,160	3	1.7% 0.0%	Calculated at half area
	Bathrooms / Showers / Changing - Female Responders	21.7	234	235	1	0.4%	
	Lavatories Water Closets	2					
	Showers	2					
Restrooms	Lockers Bathrooms / Showers / Changing - Male Responders	7 38.6	416	400	-16	-3.8%	
	Lavatories	3					O.W. Charles
	Water Closets / Urinals Showers	3					(2) Water Closet(s), (2) Urinal(s)
	Lockers	16		200		5.00/	
Laundry Fitness	Laundry Room Fitness Room	22.3 111.5	240 1,200	226 1,129	-14 -71	-5.8% -5.9%	
Recreation	Recreation Room	33.4	360	360	0	0.0%	
	SUBTOTAL DAY ROOM & RESIDENTIAL AREA	693.5	7,465	7,403	-62	-0.8%	
	ADMINISTRATIVE AREA Lobby Area	9.3	100	99	-1	-1.0%	
Lobby	Main Entry Vestibule	5.9	64	69	5	7.8%	
	Admin & Training Restrooms Female Lavatories	27.1	292	336	44	15.1%	
	Female Water Closets	2					
	Male Lavatories	2					(4) ADA Metas Claset (4) Metas Claset(a) (4) Heisel(a)
	Male Water Closets / Urinals Administration & Training Break Room	9.3	100	100	0	0.0%	(1) ABA Water Closet, (1) Water Closet(s), (1) Urinal(s)
	Administration Assistant	5.9	64	65	1	1.6%	
	Assistant Chief / Shift Supervisor Assistant Chief of Fire Prevention	11.1 11.1	120 120	119 123	-1 3	-0.8% 2.5%	Asst. Chief of Operations
Admin and	Assistant Chief of Prevention Assistant Chief of Operations / Shift Supervisor's Dorm Room	9.3	100	123	24	24.0%	
Offices	Chief's / Supervisor's Bathroom Chief's Conference Room	9.3 11.1	100 120	109 120	9	9.0%	(1) Lavatory, (1) Shower, (1) Water Closet
	Deputy Chief's Office	11.1	120	119	-1	-0.8%	
	EMS Office Fire Chief's Dorm Room	5.9 9.3	64 100	64 124	0 24	0.0% 24.0%	
	Fire Chief's Office	11.1	120	120	0	0.0%	
	General Administration Storage HAZMAT / Safety Office	7.4 11.1	80 120	80 119	0	0.0%	
	Inspector's Office(s) / Workstation(s)	11.1	128	132	4	3.1%	
	Station Chief Office / Watch Desk	11.1	120	120	0	0.0%	Station Chief / Station Capt.
	Union Representative - Office Computer Training / Testing Room	9.3	100 210	100 200	-10	0.0% -4.8%	
Training and Testing	Training Officer Office Training Room	9.3	100	112	12 -27	12.0%	Asst. Chief of Training
resung	Training Room Training Room Storage	52.0 7.4	560 80	533 72	-27 -8	-4.8% -10.0%	
Logistics	Logistics Office	7.4	80	92	12	15.0%	
	Logistics Storage Air Force Reserve and Active Duty Mobility / Deployment Gear Stor.	24.2 18.6	260 200	327 200	67 0	25.8% 0.0%	
Reserve	Air Force Reserve Firefighter PPE Gear	22.3	240	225	-15	-6.3%	10 SF / Reservist
	Air Force Reserve Supervisor Air Force Reserve Workstations	11.1 17.8	120 192	116 177	-4 -15	-3.3% -7.8%	
	SUBTOTAL TRAINING & ADMINSTRATIVE AREA	393.3	4,234	4,296	62	1.5%	
MERGENCY	CONTROL CENTER (ECC)						
	ECC Dispatcher ECC IT Room	35.7 5.6	384 60	352 58	-32 -2	-8.3% -3.3%	
ECC	ECC Kitchenette	1.9	20	20	0	0.0%	
	ECC Restroom ECC Supervisor	4.5 5.9	48 64	48 58	0 -6	0.0% -9.4%	
	SUBTOTAL E.C.C. AREA	53.5		536	-40	-6.9%	
	FIRE STATION NET ASSIGNED FLOOR AREA	2,780.6	29,931	30,098	167	0.6%	
NFRASTRUC							
acility Maint.	Janitor	14.0	151	23	-128	-84.7%	1/2% of Net Assigned Area
Mechanical / Electrical	Electrical Rooms Mechanical Room - Admin Area	56.0 24.5	603 264	515 696	-88 432	-14.6% 163.6%	2% of Net Assigned Area Based upon Conditioned Area
Telecomm / IT	Base IT / Comms Room (s)	11.1	120	264	144	120.0%	Dased upon Conditioned Area
	IT / Comms	5.6 7.4	60 80	61 80	1	1.7%	Resed on number of Structural and/or ADEE C
Vending	Vending / Recycling SUBTOTAL INFRASTRUCTURE AREA	7.4 158.8		1,639	- 71	0.0% -4.1%	Based on number of Structural and/or ARFF Cos.
	FIRE STATION NET FUNCTIONAL AREA			31,737	97	0.3%	
ION-FUNCTION		_,,	,,	,,,,,,,,,,,,,,,,,,,,,,,,,,,,,,,,,,,,,			
Circulation	Corridors, Halls, and other Interior Circulation	417.1	4,490	3,137	-1,353	-30.1%	15% of Net Assigned Area
Entries Walls	Covered Exterior Entries Interior Partitions and Walls	222.4	2,394	158 2,773	158 378	0.0% 15.8%	Calculated at half area 8% of Net Assigned Area
vvalls	SUBTOTAL NON-FUNCTION AREA	639.5		6,068	-816	-11.9%	O O I NEL Assigned Aled
					The state of the s		
	TOTAL FIRE STATION GROSS AREA	3,578.9	38,525	37,805	-720	-1.9%	



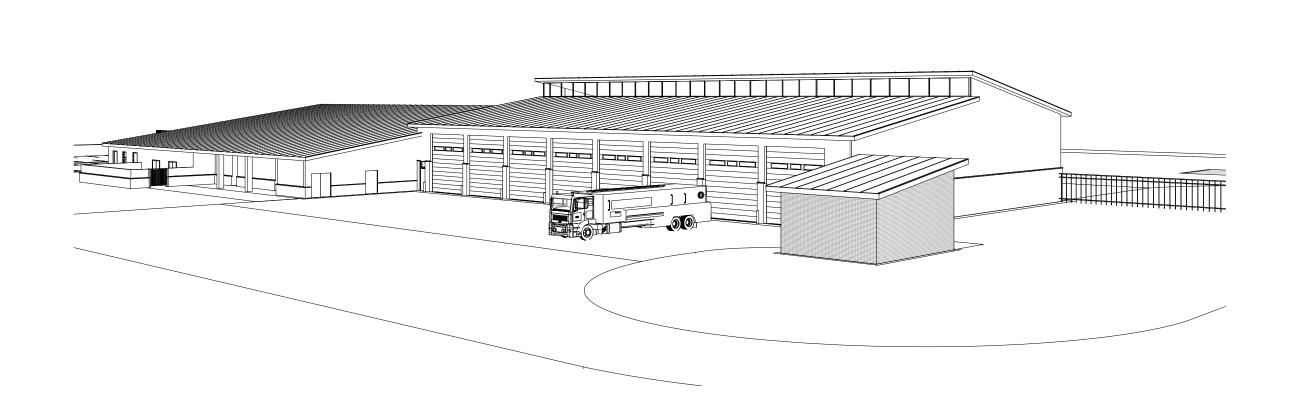

COMPOSITE B - LARGE HEADQUARTERS COMBINATION OVERALL
PERSPECTIVE

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Jacobs Project No.:


Drawing Title:

COMPOSITE B - LARGE HEADQUARTERS COMBINATION PROGRAM AND PERSPECTIVES

DECEMBER 2013

Designed By:LEG
Drawn By: KLW
Checked By: JW

Drawing No.:
CO106

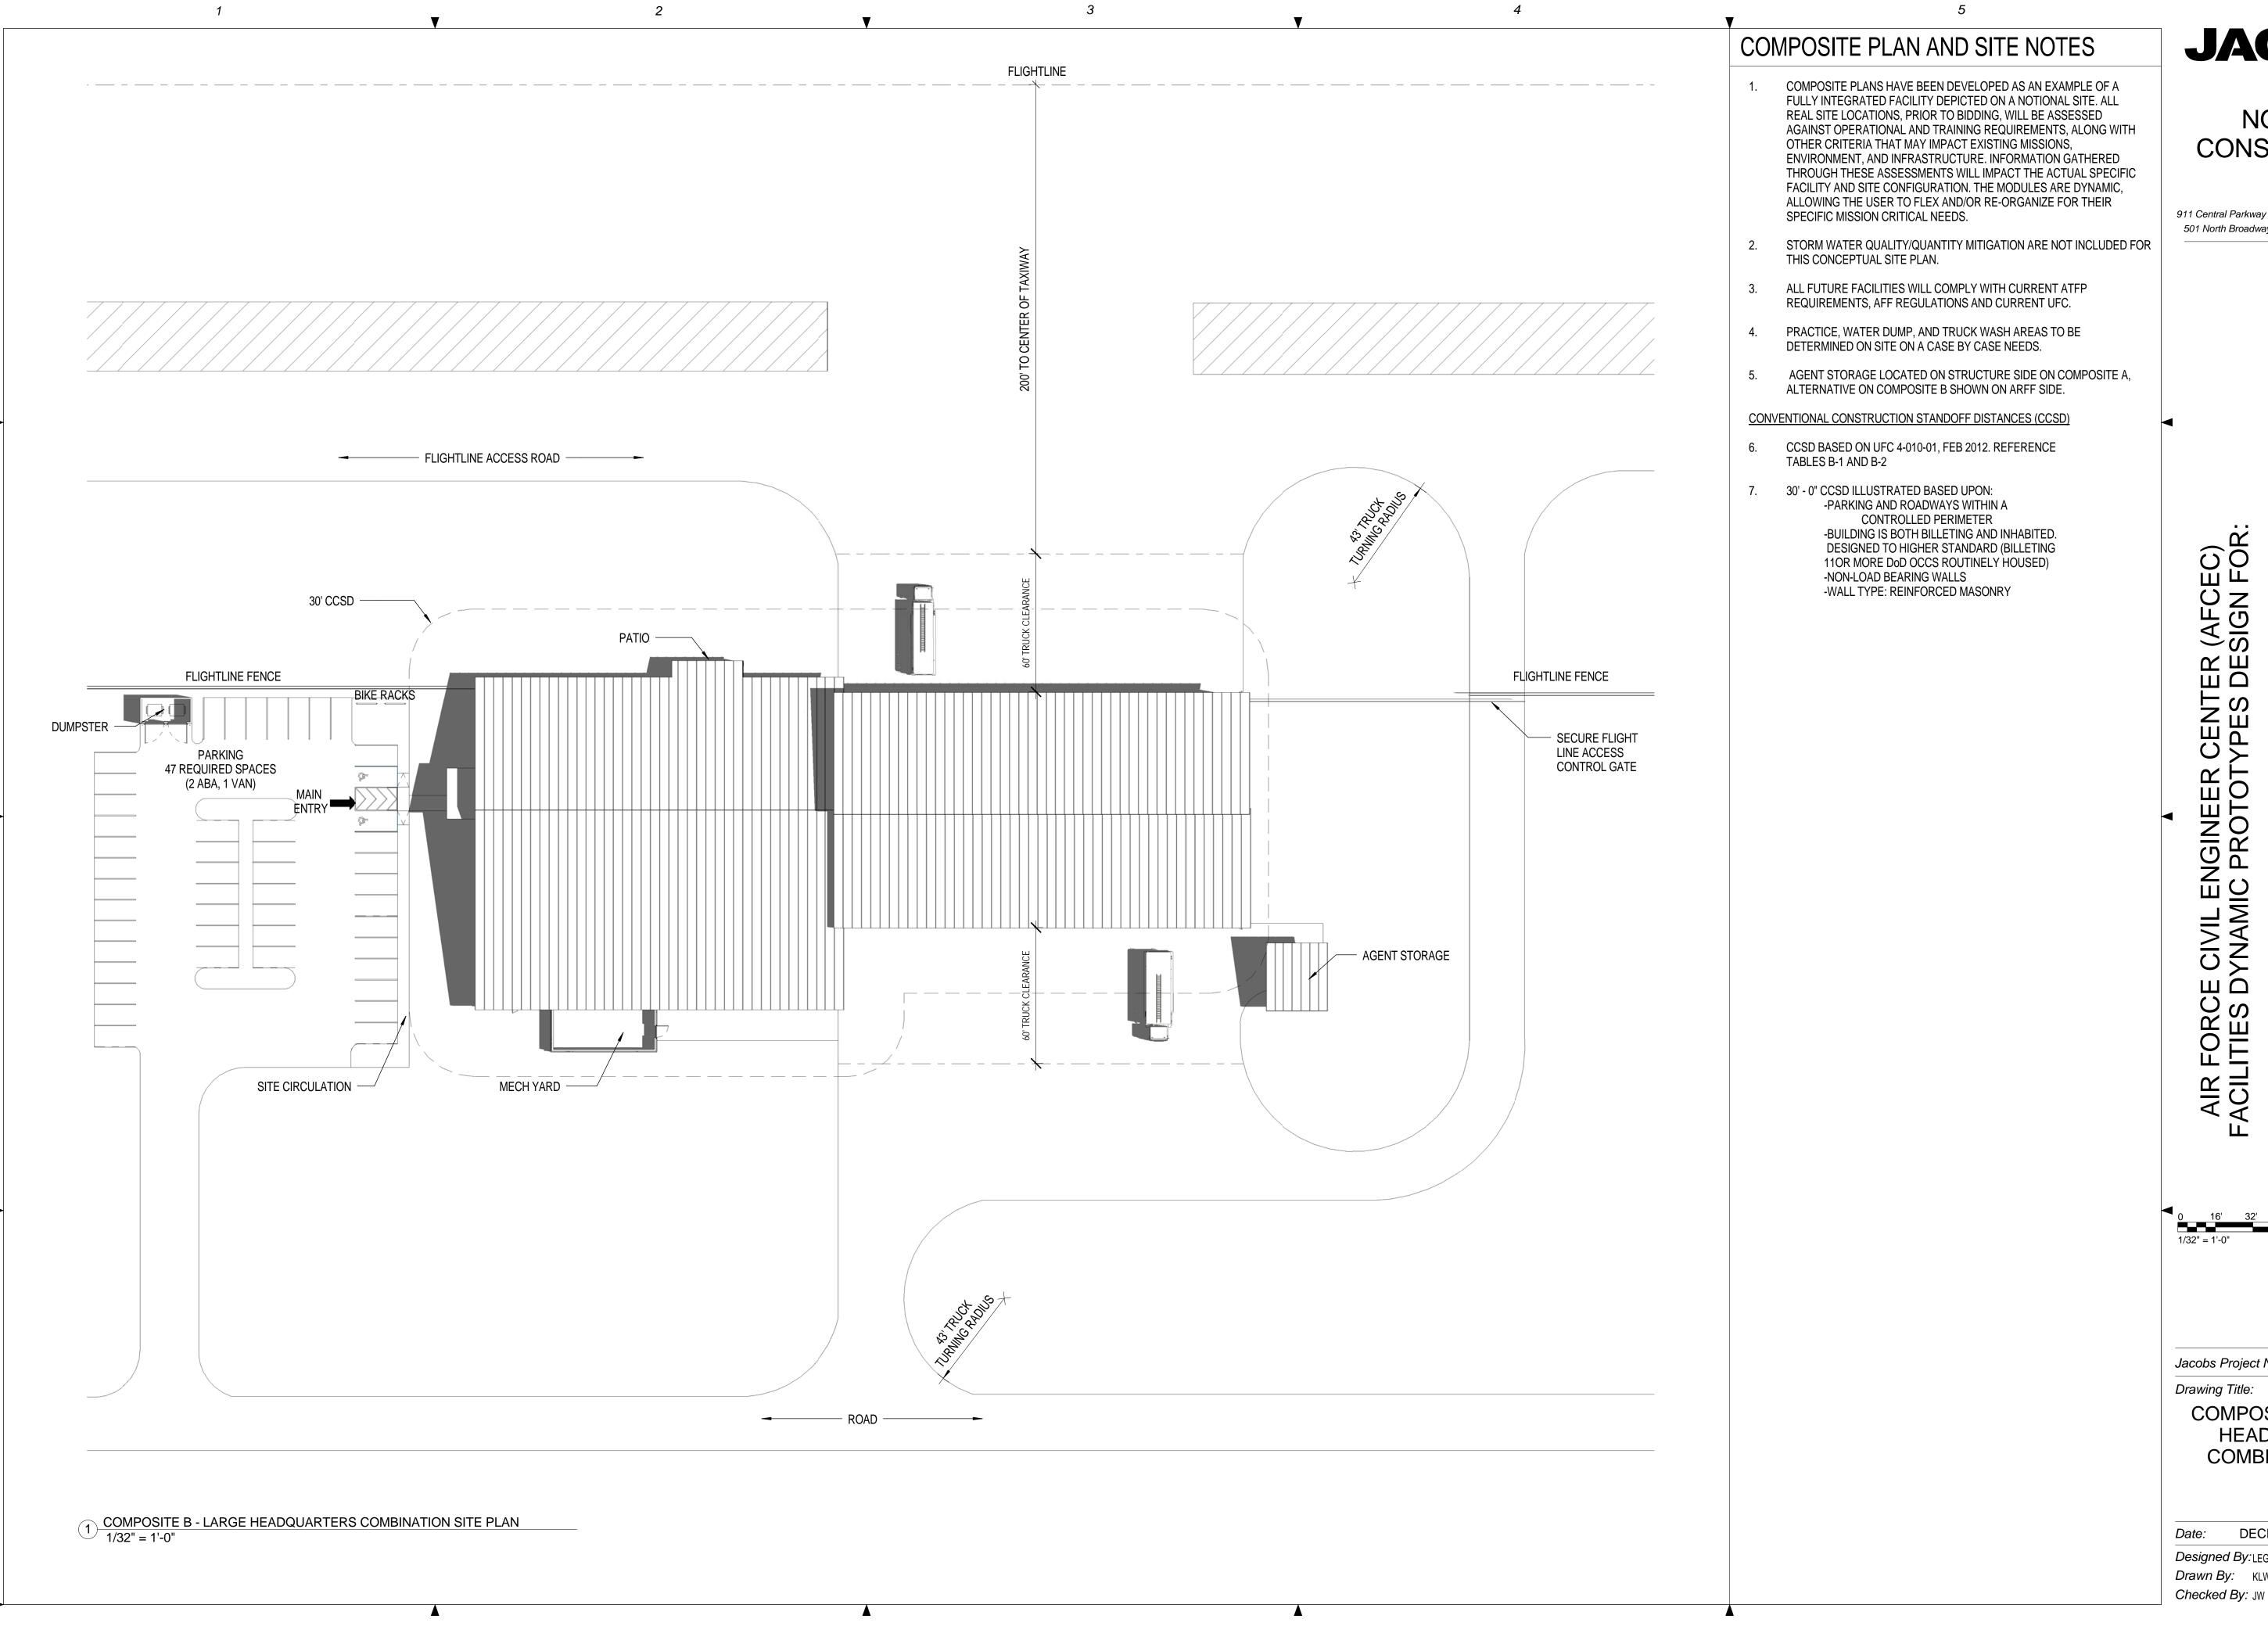

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Jacobs Project No.:

COMPOSITE B - LARGE HEADQUARTERS **COMBINATION SITE**

DECEMBER 2013

Designed By:LEG Drawn By: KLW

CO107

Drawing No.:

RESERVE

TESTING

ADMINISTRATION

TRAINING

DISPATCH (ECC)

LOGISTICS

BREAK ROOM

HOTELING

RECREATION

JACOBS

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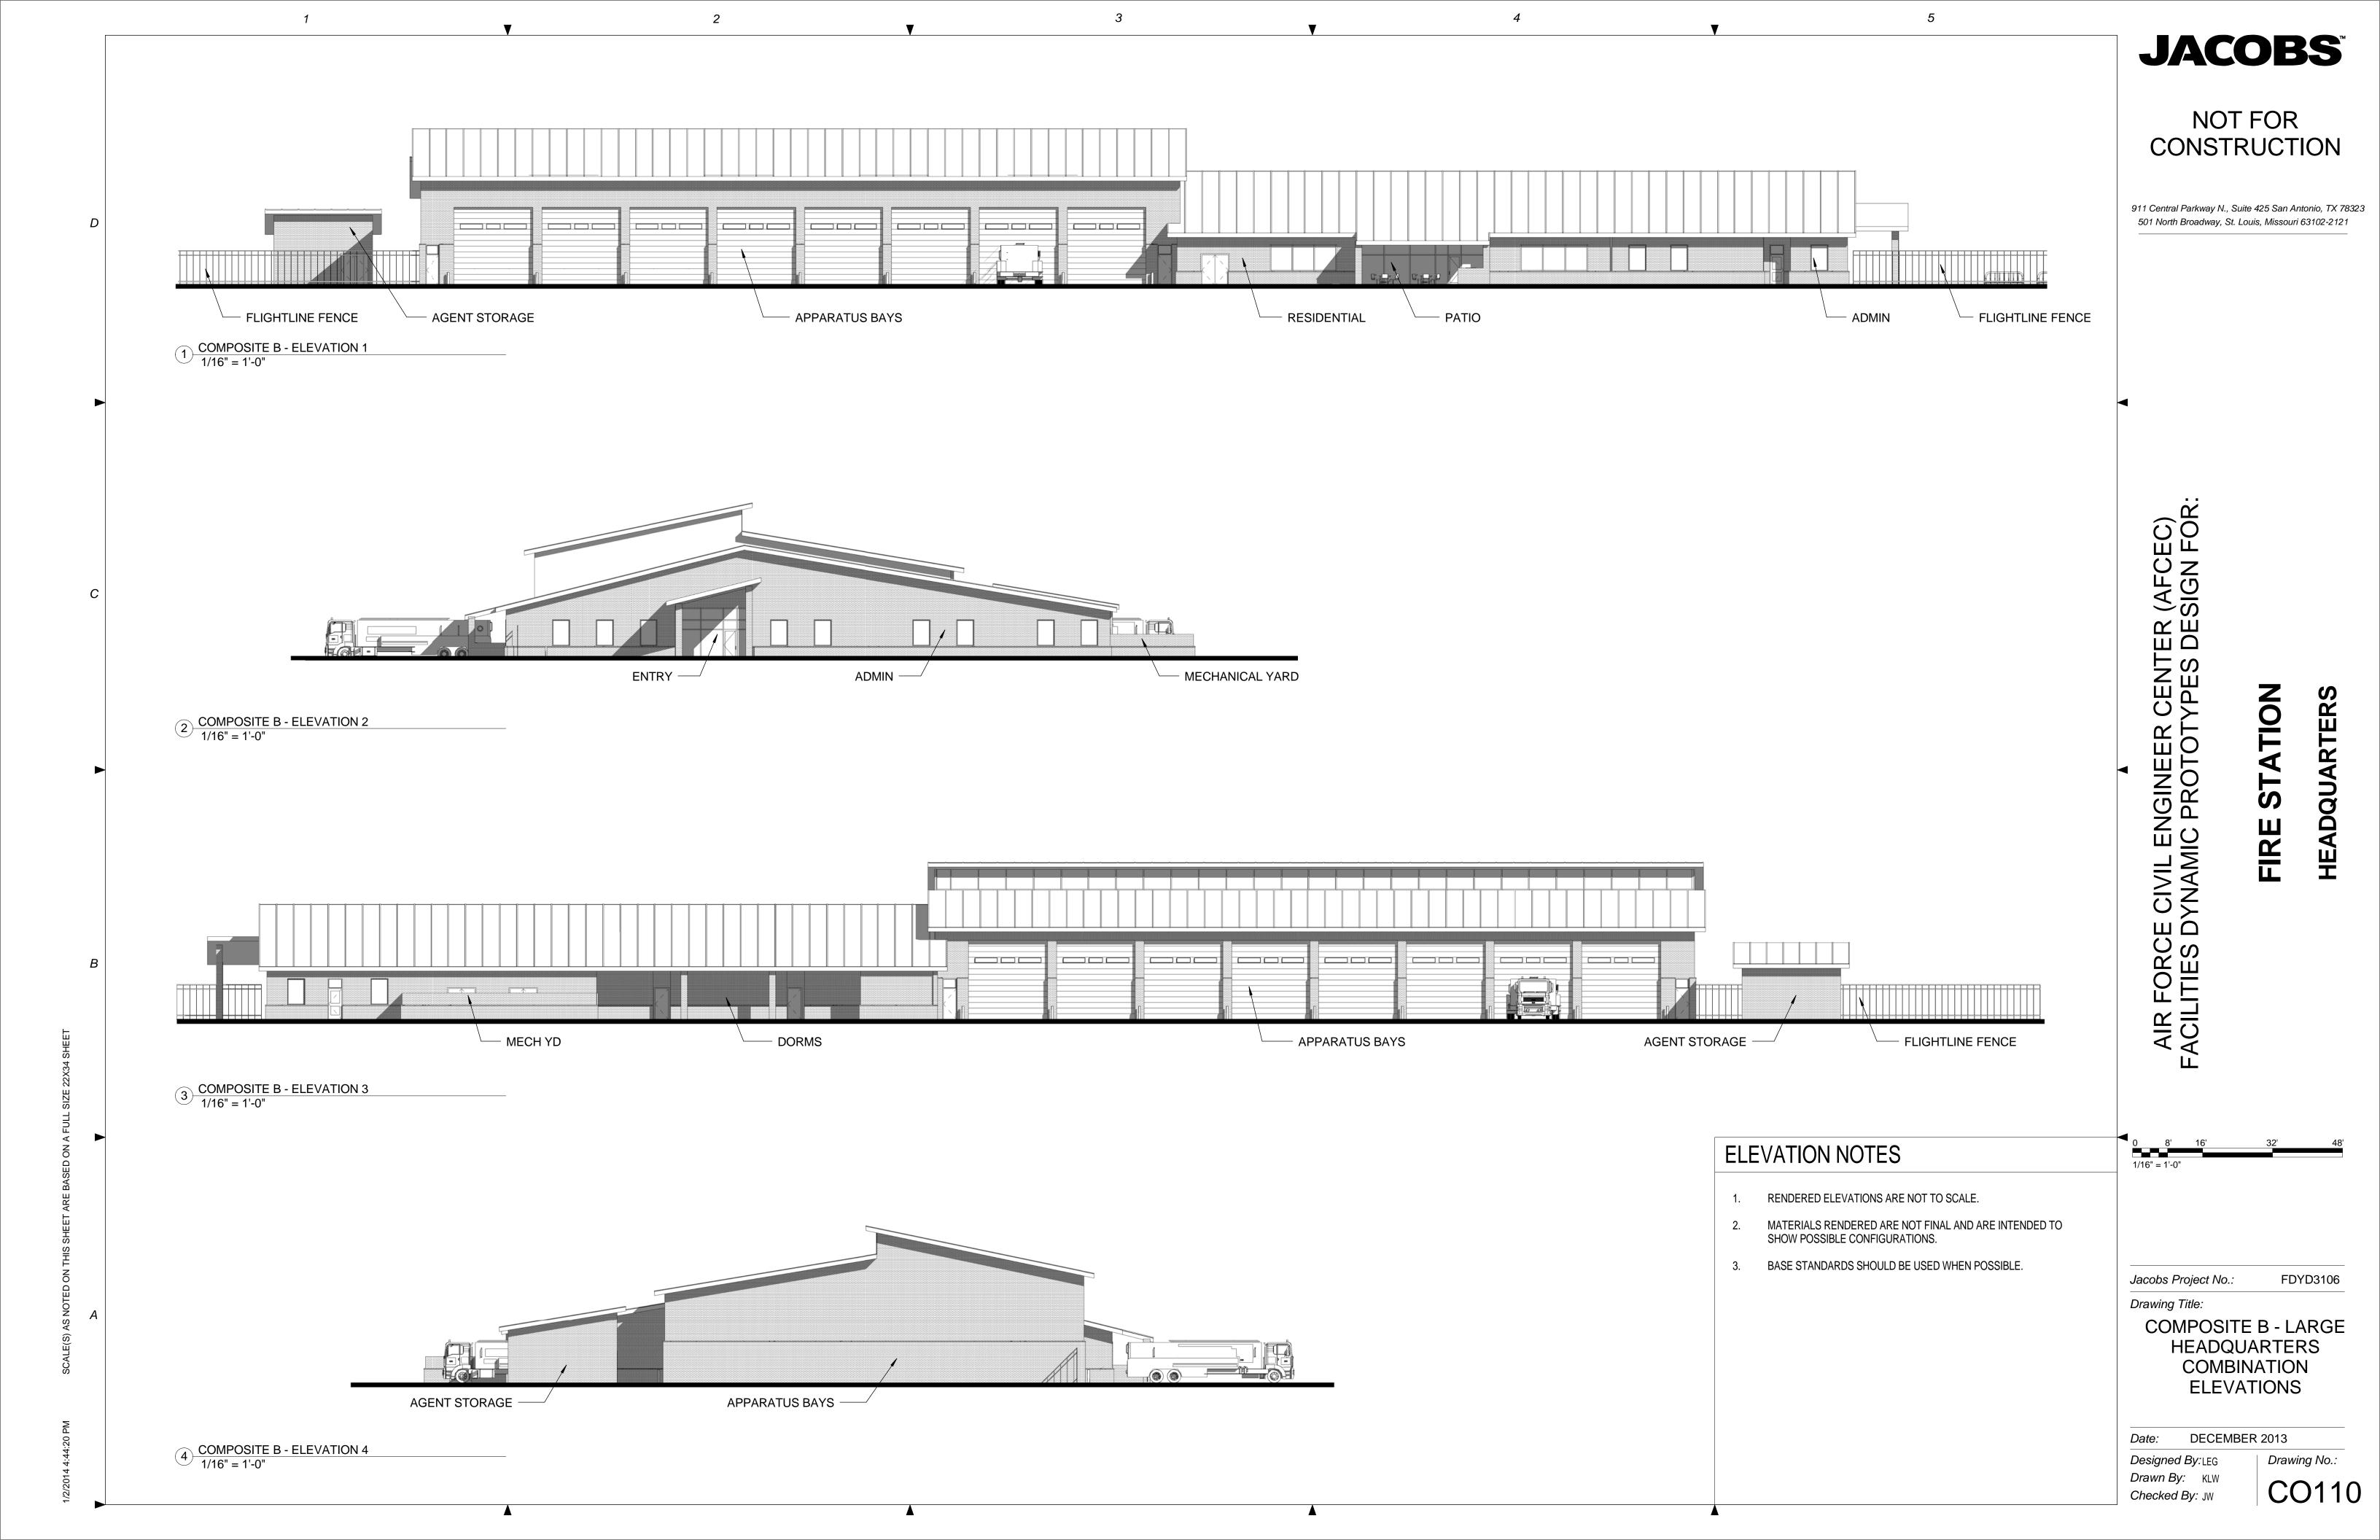
HEADQUARTERS **COMBINATION OVERALL** FLOOR PLAN

DECEMBER 2013 Date:

Designed By:LEG Drawn By: KLW Checked By: JW


Drawing No.: CO108





DECEMBER 2013 Drawing No.:

COMPOSITE A - HEADQUARTERS ARFF ENTRY PERSPECTIVE

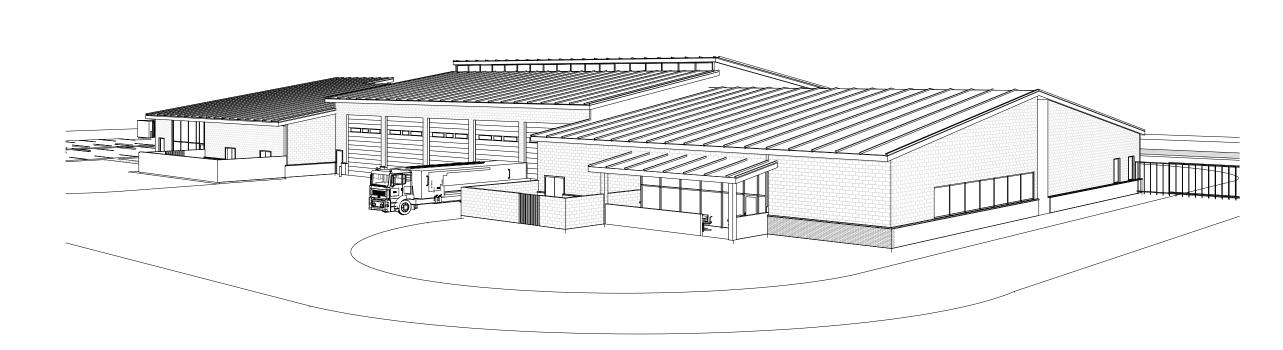

2 COMPOSITE A - HEADQUARTERS ARFF OVERALL PERSPECTIVE

FIRE STATION DESIGN EFFICIENCY PREDESIGN AREA MATRIX

Entries Covered Exterior Entries

Walls Interior Partitions and Walls

Prototype Fire Station - HQ/Main ARFF - Composite A

0 Structural, 8 ARFF Companies with 23 Responders

Flightline Fire Extinguishing Maintenance and Storage

Agent Storage (ARFF)
SUBTOTAL MAINTENANCE. & APPARATUS AREA

Bathrooms / Showers / Changing - Female Responders

Bathrooms / Showers / Changing - Male Responders

SUBTOTAL DAY ROOM & RESIDENTIAL AREA

Flightline Fire Extinguishing Tank Recovery Ext. Covered Storage

Spare Flightline Fire Extinguishing Tank Exterior Covered Storage

Small Vehicle (two per bay, if needed)

Modules

Apparatus Support

Day

Restrooms

IAINTENANCE & APPARATUS AREA Apparatus Bay

> Medium ARFF Large ARFF

EMS Storage - Closet

Hose Storage Infectious Control

PPE Gear Storage

DAY ROOM & RESIDENTIAL AREA

Dorm Rooms Dorm Rooms

Laundry Laundry Room

Fitness Room

TRAINING & ADMINISTRATIVE AREA

Lobby Area

Main Entry Vestibule Admin & Training Restrooms

Female Lavatories

Female Water Closets Male Lavatories

Male Water Closets / Urinals

Administration Assistant

Administration & Training Break Room

Assistant Chief of Operations / Shift Supervisor's Dorm Room

Air Force Reserve and Active Duty Mobility / Deployment Gear Stor.

SUBTOTAL TRAINING & ADMINSTRATIVE AREA

FIRE STATION NET ASSIGNED FLOOR AREA

SUBTOTAL E.C.C. AREA

SUBTOTAL INFRASTRUCTURE AREA

SUBTOTAL NON-FUNCTION AREA

TOTAL FIRE STATION GROSS AREA

FIRE STATION NET FUNCTIONAL AREA

Assistant Chief / Shift Supervisor Assistant Chief of Fire Prevention

Chief's / Supervisor's Bathroom Chief's Conference Room Deputy Chief's Office EMS Workstation Fire Chief's Dorm Room Fire Chief's Office

General Administration Storage HAZMAT / Safety Office

Inspector's Office(s) / Workstation(s)

Air Force Reserve Firefighter PPE Gear Air Force Reserve Supervisor

Air Force Reserve Workstations

Station Chief Office / Watch Desk Computer Training / Testing Room

Training Room Storage Logistics Office

Logistics Storage

EMERGENCY CONTROL CENTER (ECC) ECC Dispatcher ECC IT Room

> ECC Kitchenette ECC Restroom

Electrical Rooms

Telecomm / IT Base IT / Comms Room(s)
IT / Comms

Mechanical Room - Admin Area

Circulation Corridors, Halls, and other Interior Circulation

Mechanical Room - Responders Area

Training and Training Officer Office

Testing Training Room

Logistics

ECC

INFRASTRUCTURE Facility Maint. Custodial

NON-FUNCTION SPACE

Mechanical /

Day Room

Hoteling Stations

Water Closets howers

Water Closets / Urinals

Protective Clothing Laundry SCBA Compressor Room SCBA Maintenance Room

Spare PPE Gear Storage

Equipment Wash / Disinfection Fire Extinguisher Inspection

HAZMAT / CBRN Equipment Storage

Work Room / Equipment Maintenance

Apparatus Bays Large Structural

COMMENTS

Calculated at half area

Calculated at half area

culated at half area

2) Water Closet(s), (2) Urinal(s)

) ABA Water Closet

0.0% Asst. Chief of Operations

7.0% (1) Lavatory, (1) Shower, (1) Water Closet

Station Chief / Station Capt.

/2% of Net Assigned Area

Based upon Conditioned Area

Based upon Conditioned Area

ased on number of Structural and/or ARFF Cos.

2% of Net Assigned Area

15% of Net Assigned Area

Calculated at half area

218 10.6% 8% of Net Assigned Area

3.0% Asst. Chief of Training

10 SF / Reservist

0.0%

105 2.5%

10 0.0%

171 10.6%

181 0.7%

-675 -11.4%

2,874 -1,005 -25.9%

1) Urinal(s), (1) ABA Water Closet, (1) Water Closet(s)

Combination of dining, kitchen, and living

One workstation for every three Responders

12.5%

30 0.2%

0.0%

-11.1%

-1.6%

-24.0%

SF Delta (SF) Delta (%)

10,625

532 12,660

267

8,321

4,302

25,870

27,651

5,272

79%

3,104.5 33,418 32,923 -494 -1.5%

-136

SM SF

981.0 10,560

48.8 525 1,173.3 12,630

320

8,457

389.9 4,197

53.5

48.6

2,402.4 25,860

2,551.9 27,470

360.4 3,879

552.6 5,948

77%

29.7

25.6

785.7

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ATION

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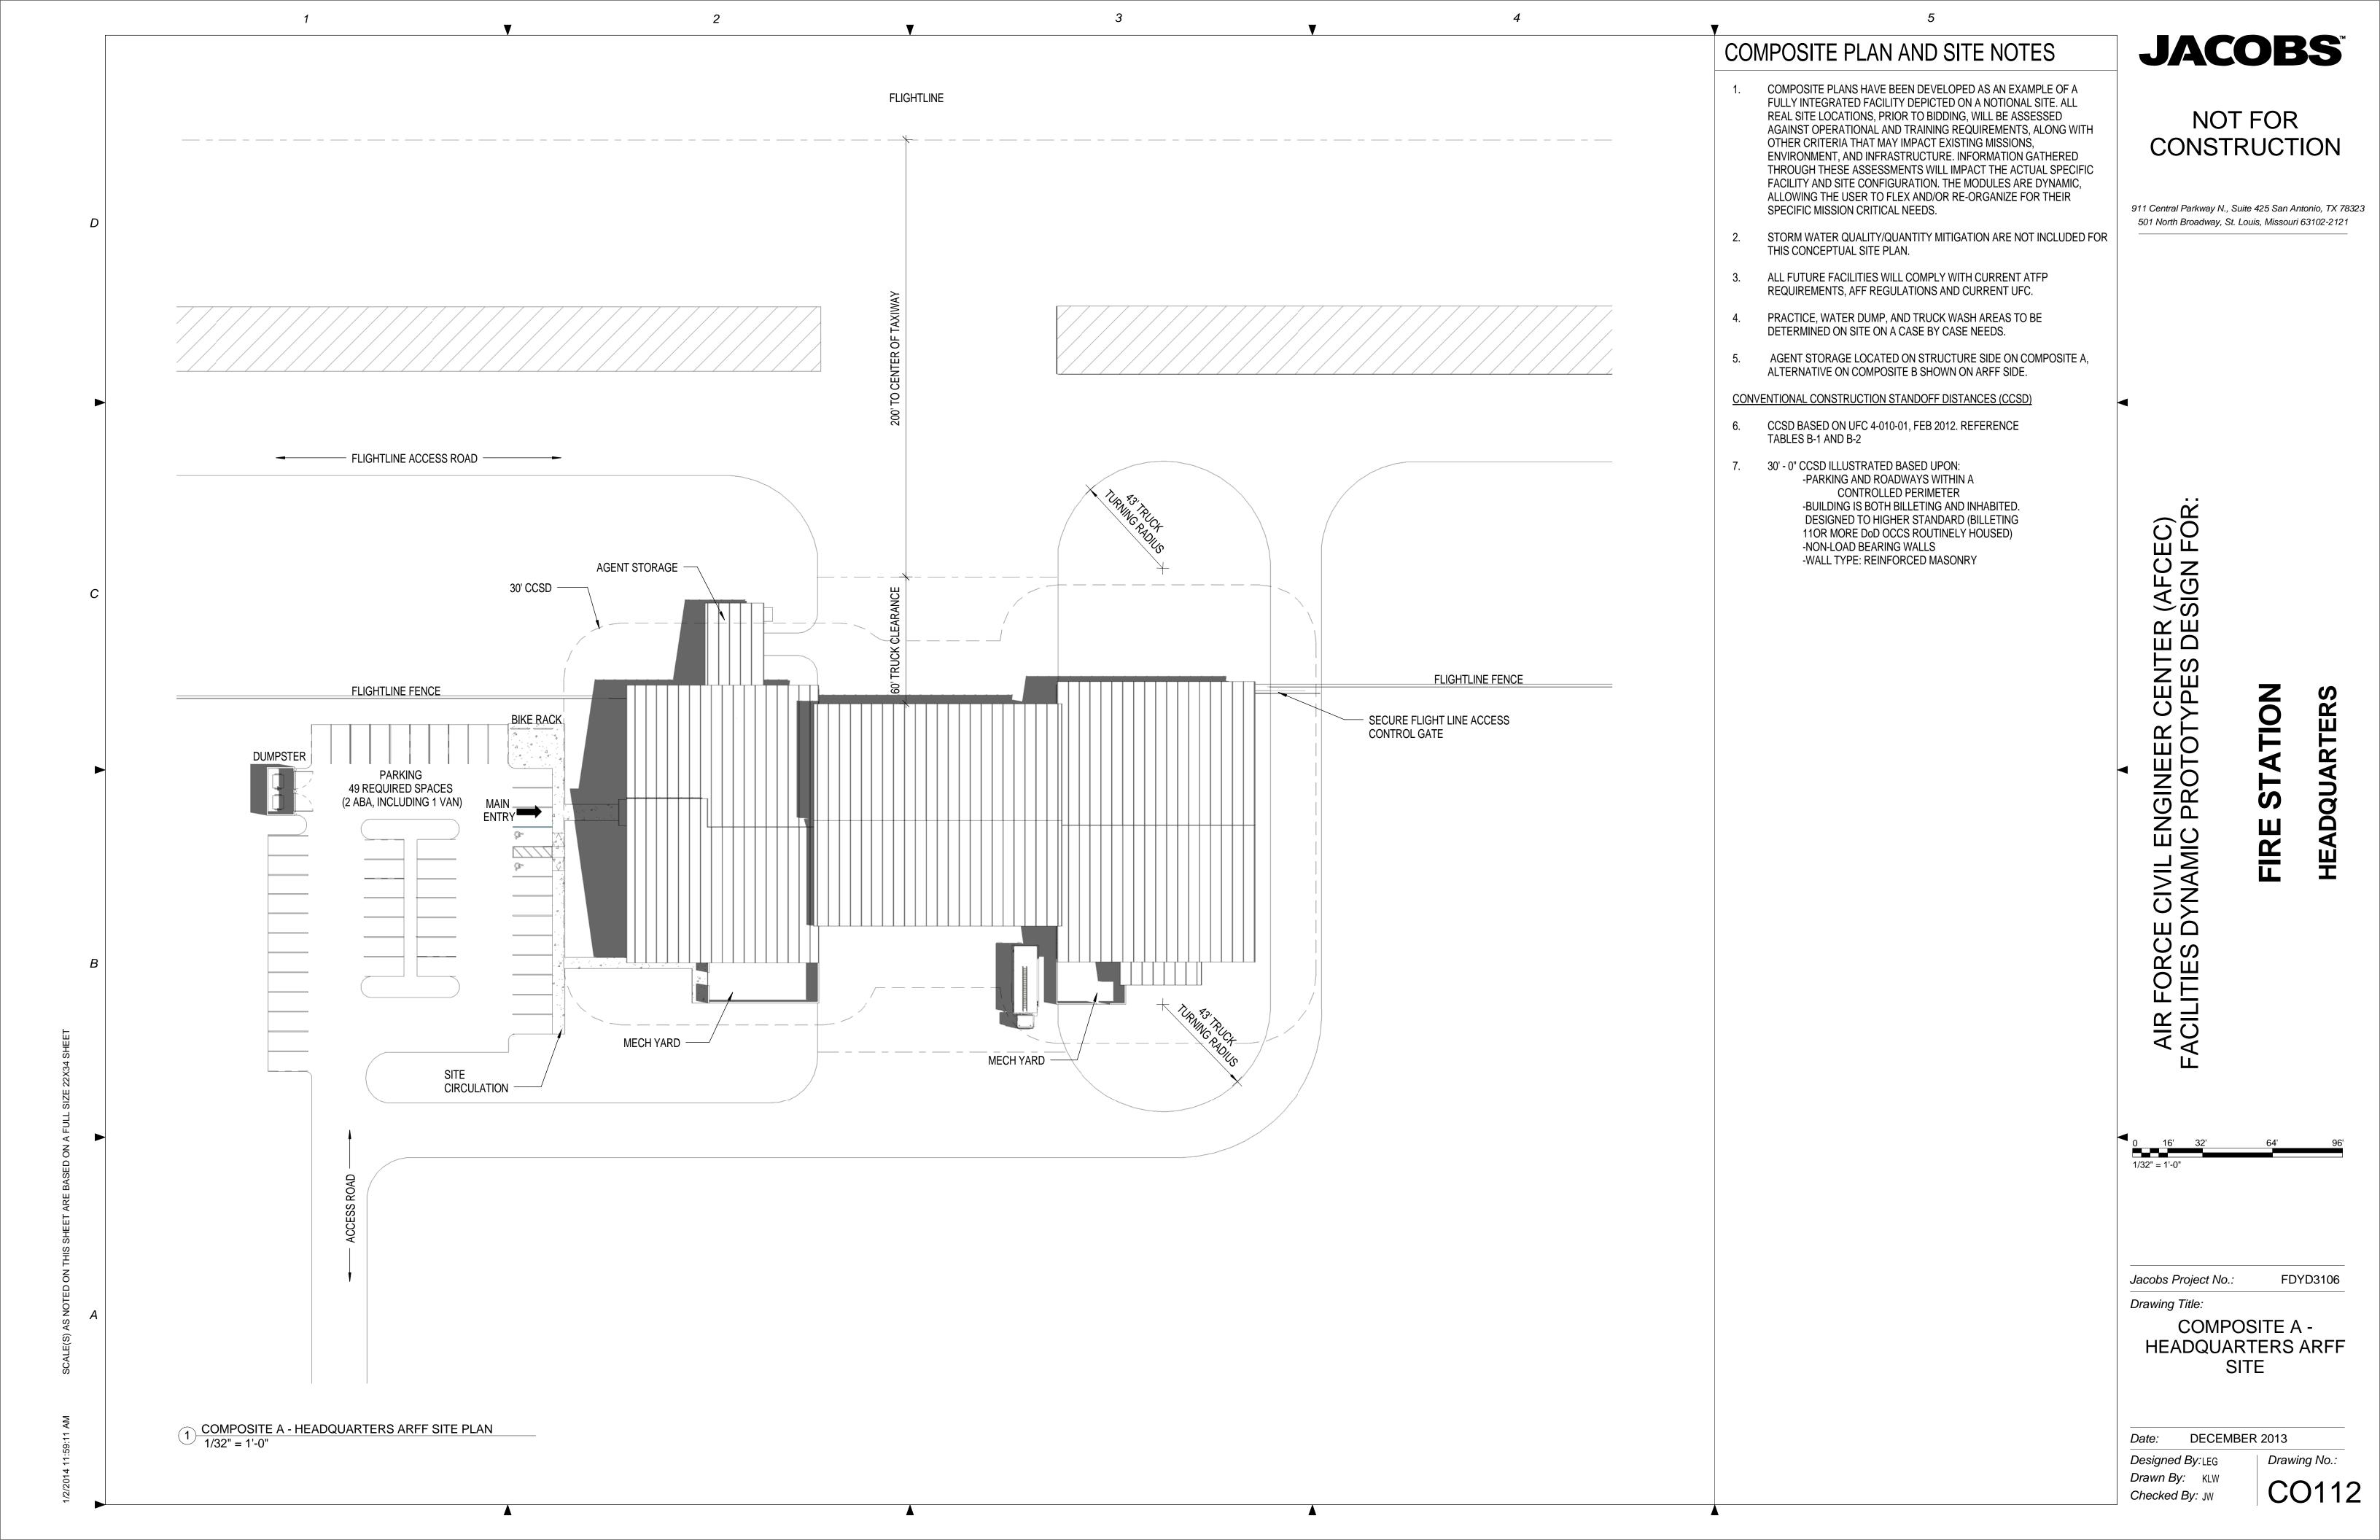
IL ENGINEER CENTER (AFCEC)
AMIC PROTOTYPES DESIGN FOR

FDYD3106 Jacobs Project No.:

Drawing Title:

COMPOSITE A -**HEADQUARTERS ARFF** PROGRAM AND PERSPECTIVES

Designed By: LEG Drawn By: KLW Checked By: JW



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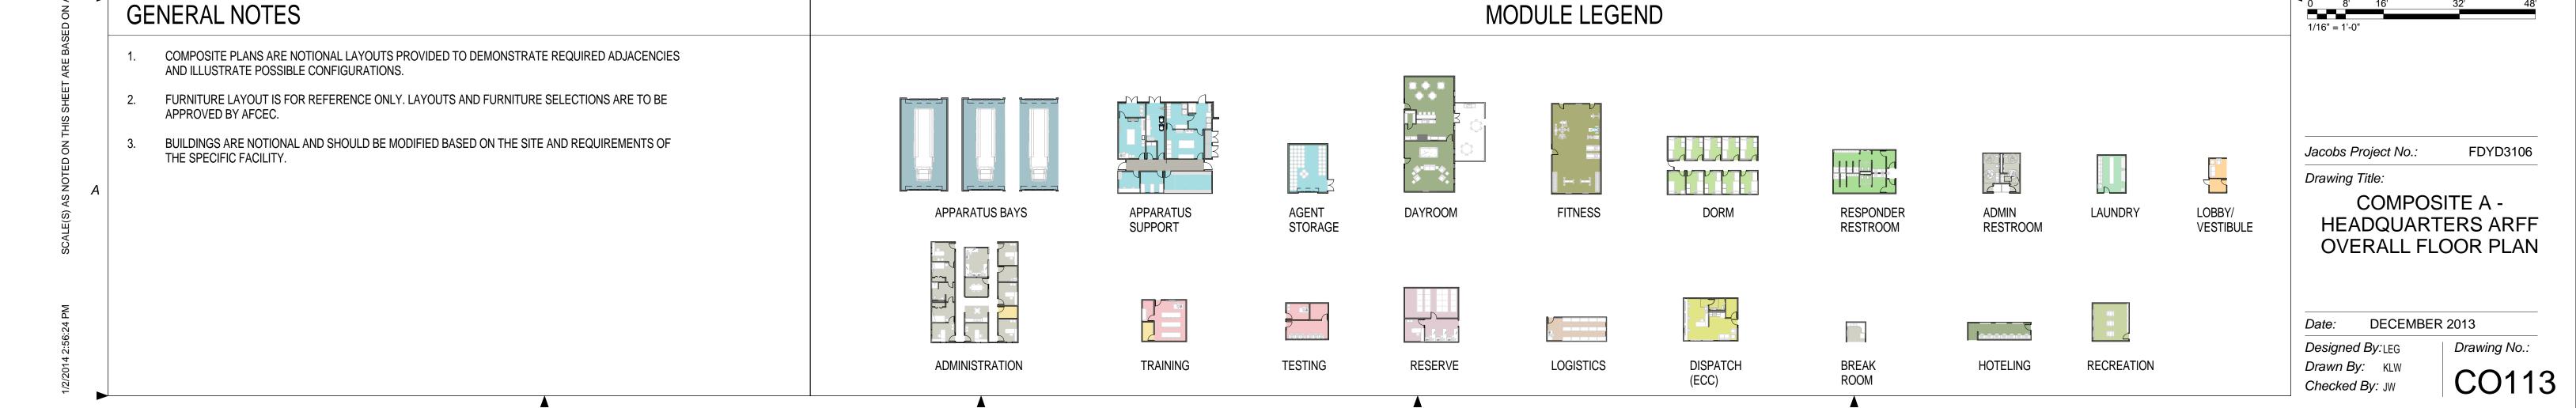
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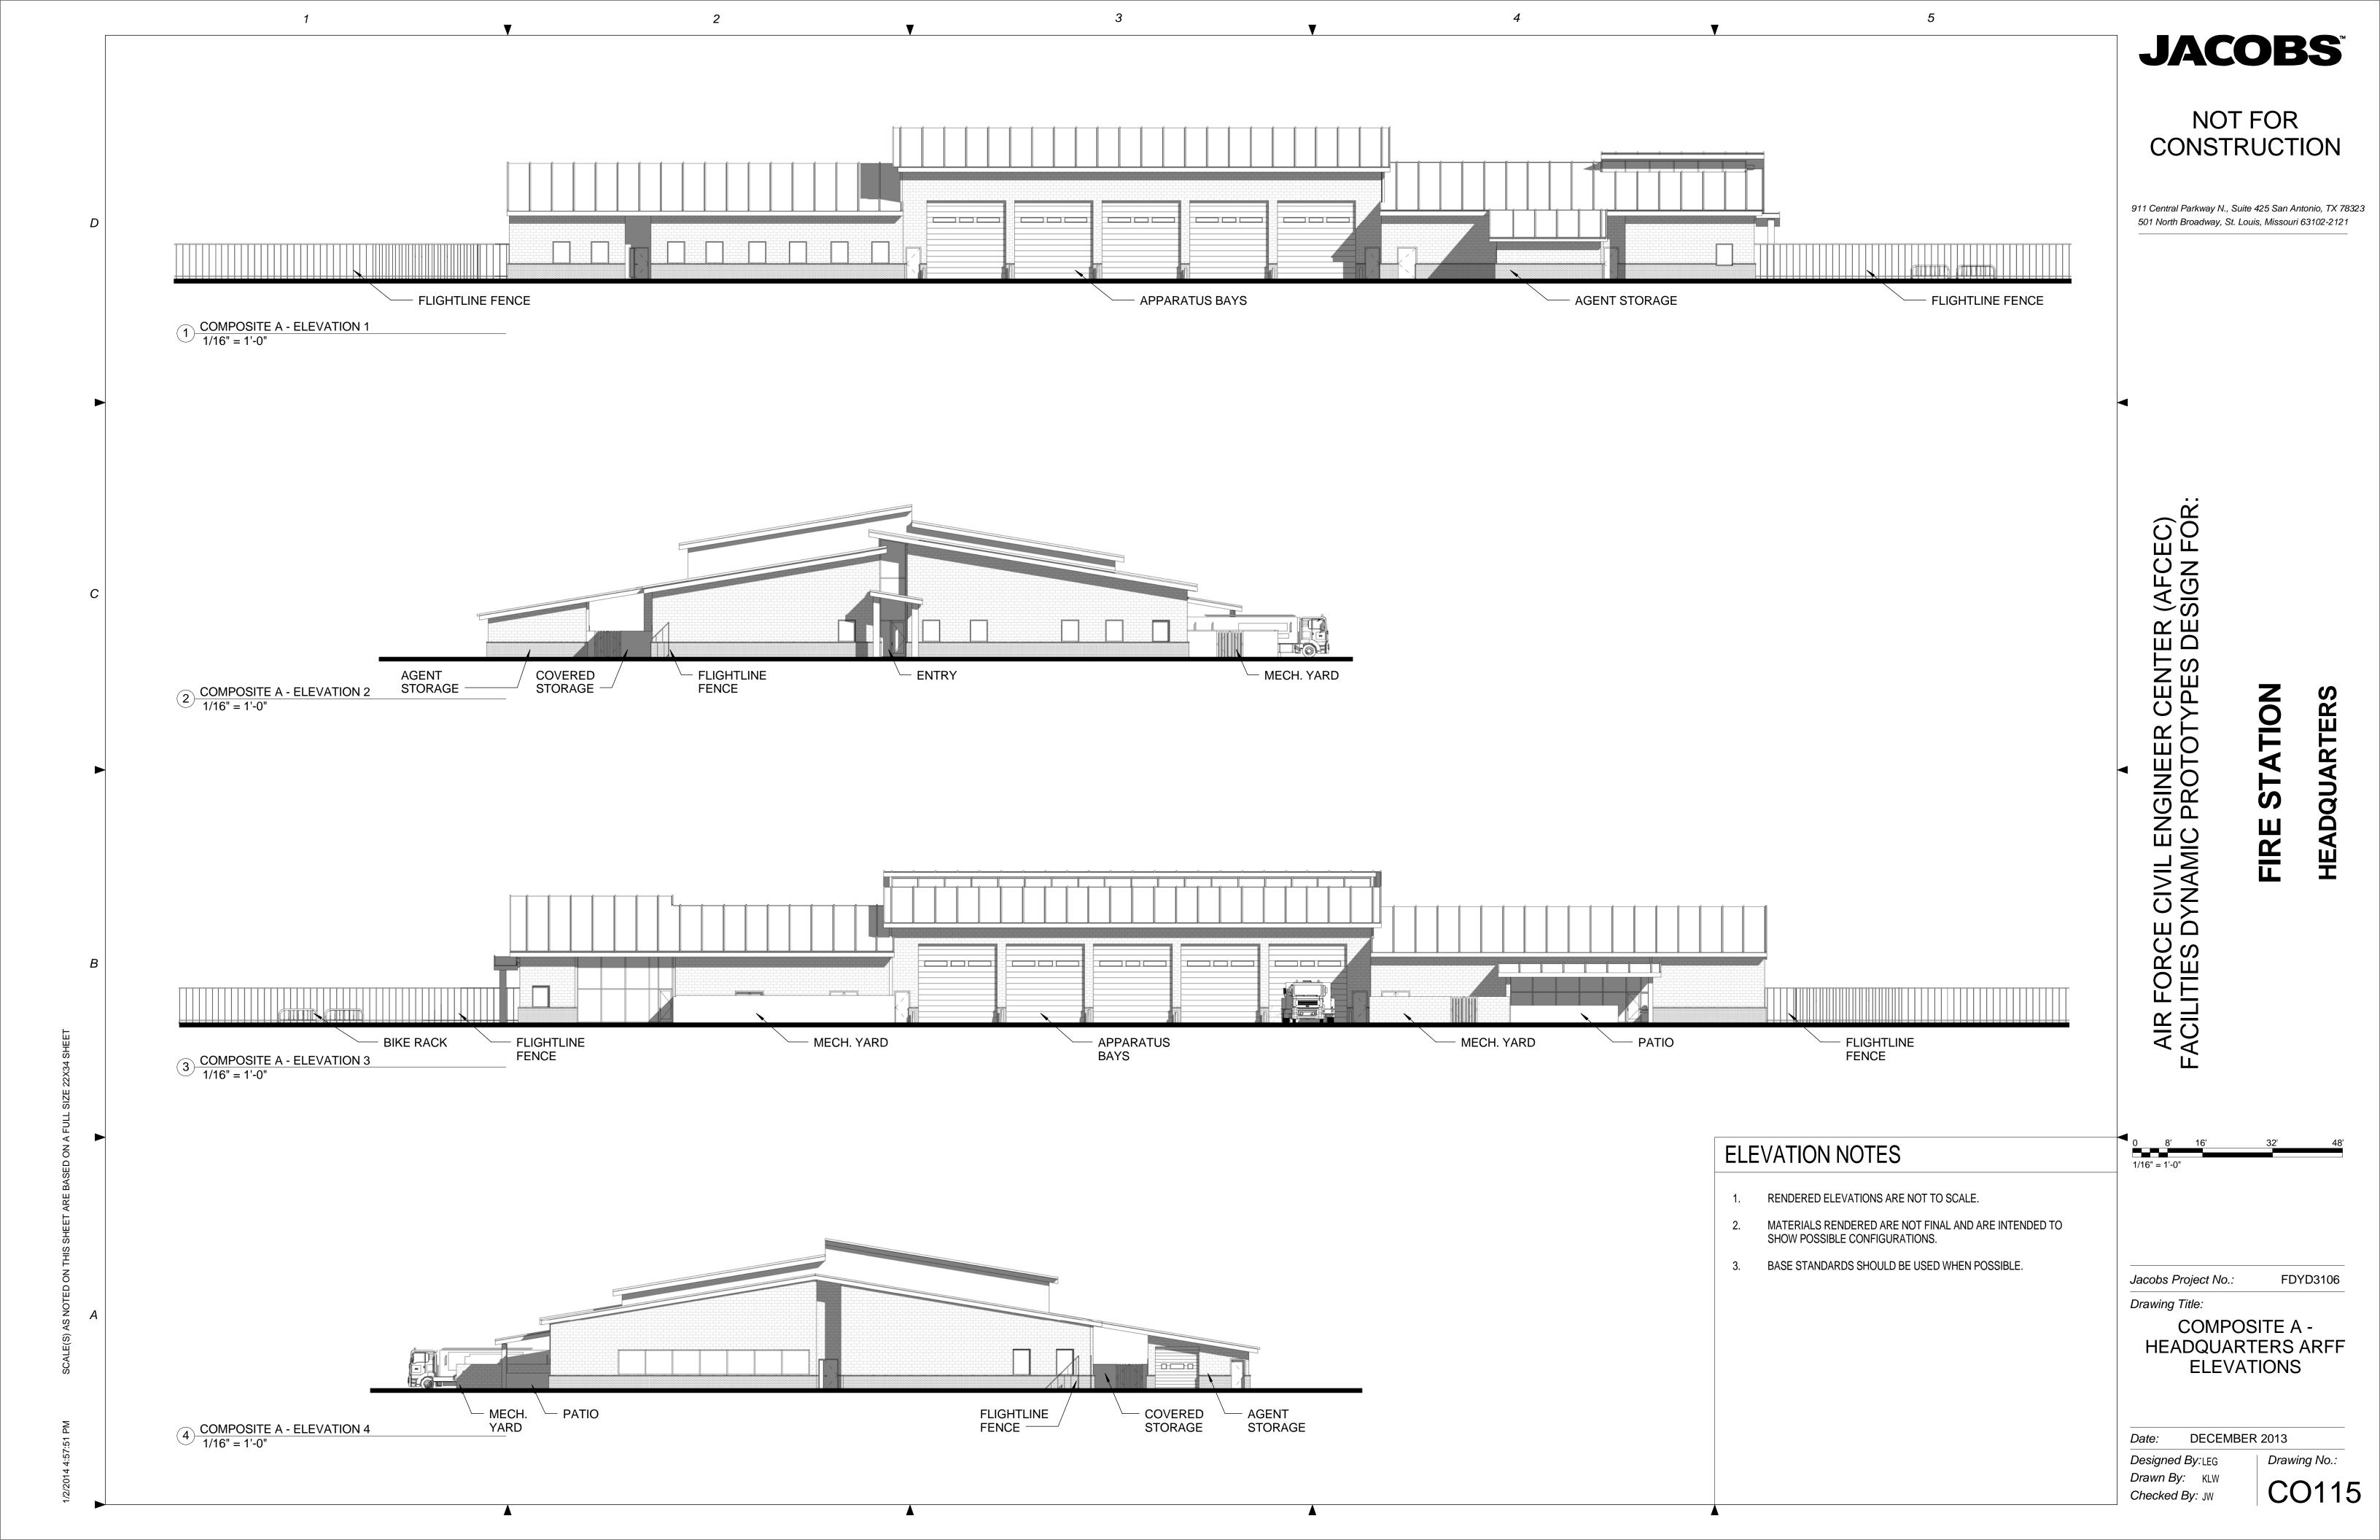
CONSTRUCTION

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501 North Broadway, St. Louis, Missouri 63102-2121







Recreation Recreation Room 33.4 330 -8.3% SUBTOTAL DAY ROOM & RESIDENTIAL AREA 785.7 8,457 8,375 -83 TRAINING & ADMINISTRATIVE AREA Lobby Area Lobby Main Entry Vestibule Admin & Training Restrooms Female Lavatories 1) ABA Water Closet Female Water Closets Male Lavatories Male Water Closets / Urinals 1) ABA Water Closet, (1) Water Closet(s), (1) Urinal(s) Administration & Training Break Room -33.0% Administration Assistant 0.0% Asst. Chief of Operations Assistant Chief / Shift Supervisor Assistant Chief of Fire Prevention Offices Chief's / Supervisor's Bathroom 13.0% (1) Lavatory, (1) Shower, (1) Water Closet Chief's Conference Room Deputy Chief's Office EMS Workstation Fire Chief's Dorm Room 25.0% Fire Chief's Office General Administration Storage HAZMAT / Safety Office Inspector's Office(s) / Workstation(s) Station Chief / Station Capt. Station Chief Office / Watch Desk Computer Training / Testing Room 3.0% Asst. Chief of Training Training and Training Officer Office Training Room Training Room Storage Logistics Office 24.4% Air Force Reserve and Active Duty Mobility / Deployment Gear Stor. 0 SF / Reservist Air Force Reserve Firefighter PPE Gear -2.1% Air Force Reserve Supervisor -2.5% Air Force Reserve Workstations SUBTOTAL TRAINING & ADMINSTRATIVE AREA 389.9 4,197 4,323 126 MERGENCY CONTROL CENTER (E **ECC** Dispatcher ECC IT Room ECC Kitchenette ECC Restroom SUBTOTAL E.C.C. AREA 53.5 FIRE STATION NET ASSIGNED FLOOR AREA 2,402.4 25,860 97 0.4% 25,957 Facility Maint. Custodial /2% of Net Assigned Area 2% of Net Assigned Area Mechanical / Electrical Rooms Electrical Mechanical Room - Admin Area Based upon Conditioned Area Telecomm / IT Base IT / Comms Room(s)
IT / Comms sed on number of Structural and/or ARFF Cos. Vending / Recycling SUBTOTAL INFRASTRUCTURE AREA 149.5 -557 -34.6% FIRE STATION NET FUNCTIONAL AREA 2,551.9 27,470 27,010 -460 -1.7% NON-FUNCTION SPACE Circulation | Corridors, Halls, and other Interior Circulation 360.4 3,879 2,826 -1,053 -27.1% 15% of Net Assigned Area Entries Covered Exterior Entries Calculated at half area Walls Interior Partitions and Walls -511 -24.7% 192.2 8% of Net Assigned Area SUBTOTAL NON-FUNCTION AREA 552.6 5,948 4,494 -1,454 -24.4% TOTAL FIRE STATION GROSS AREA 3,104.5 33,418 31,503 -1,914 -5.7% FIRE STATION DESIGN EFFICIENCY 77% 82% PREDESIGN AREA MATRIX

REQUIREMENTS FC Planning Template (Nov 2011)

SM SF

1,173.3 12,630

2,484

256.4

29.7

230.8

128.2

10,560

981.0

COMMENTS

Calculated at half area

Calculated at half area

Calculated at half area

2) Water Closet(s), (2) Urinal(s)

Combination of dining, kitchen, and living

One workstation for every three Responders

5.0%

-90.4%

2.2%

9.7%

47.1%

0.0%

-5.4%

-9.0%

SF Delta (SF) Delta (%)

10,219

12,675

2,476

Prototype Fire Station - HQ/Main ARFF - Composite B

0 Structural, 8 ARFF Companies with 23 Responders

Flightline Fire Extinguishing Maintenance and Storage

Flightline Fire Extinguishing Tank Recovery Ext. Covered Storage

Spare Flightline Fire Extinguishing Tank Exterior Covered Storage

Bathrooms / Showers / Changing - Female Responders

Bathrooms / Showers / Changing - Male Responders

SUBTOTAL MAINTENANCE. & APPARATUS AREA

Small Vehicle (two per bay, if needed)

HAZMAT / CBRN Equipment Storage

Work Room / Equipment Maintenance

Modules

Apparatus

Support

Day

Restrooms

MAINTENANCE & APPARATUS AREA Apparatus Bay

Medium Structural

EMS Storage - Closet Equipment Wash / Disinfection Fire Extinguisher Inspection

Medium ARFF Large ARFF

Hose Storage

Agent Storage Agent Storage (ARFF)

DAY ROOM & RESIDENTIAL AREA

Dorm Rooms Dorm Rooms

Day Room

Lavatories Water Closets Showers

Lavatories

Showers

Lockers Laundry Room

Fitness Room

Water Closets / Urinals

Hoteling Stations

Infectious Control

PPE Gear Storage


Protective Clothing Laundry SCBA Compressor Room SCBA Maintenance Room

Spare PPE Gear Storage

Physical Therapy / Sauna

Apparatus Bays Large Structural

(1) COMPOSITE B - HEADQUARTERS ARFF ENTRY PERSPECTIVE

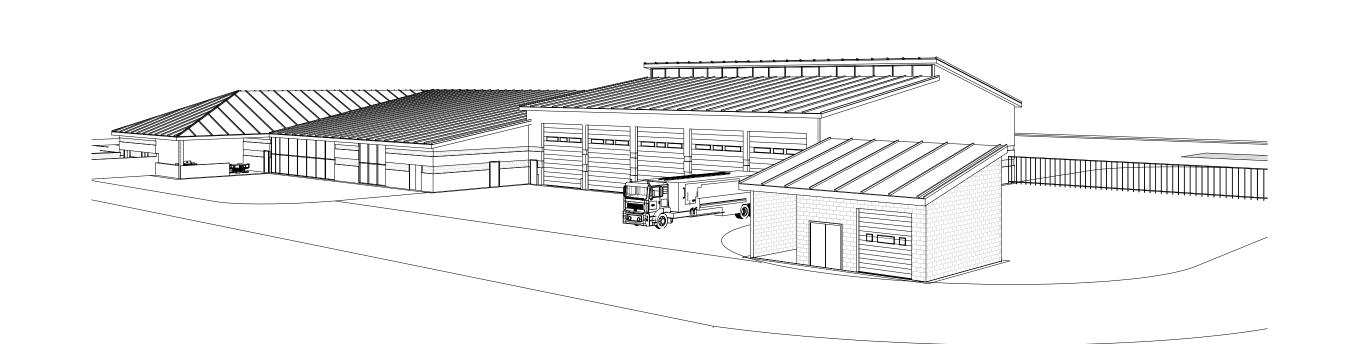

(2) COMPOSITE B - HEADQUARTERS ARFF OVERALL PERSPECTIVE

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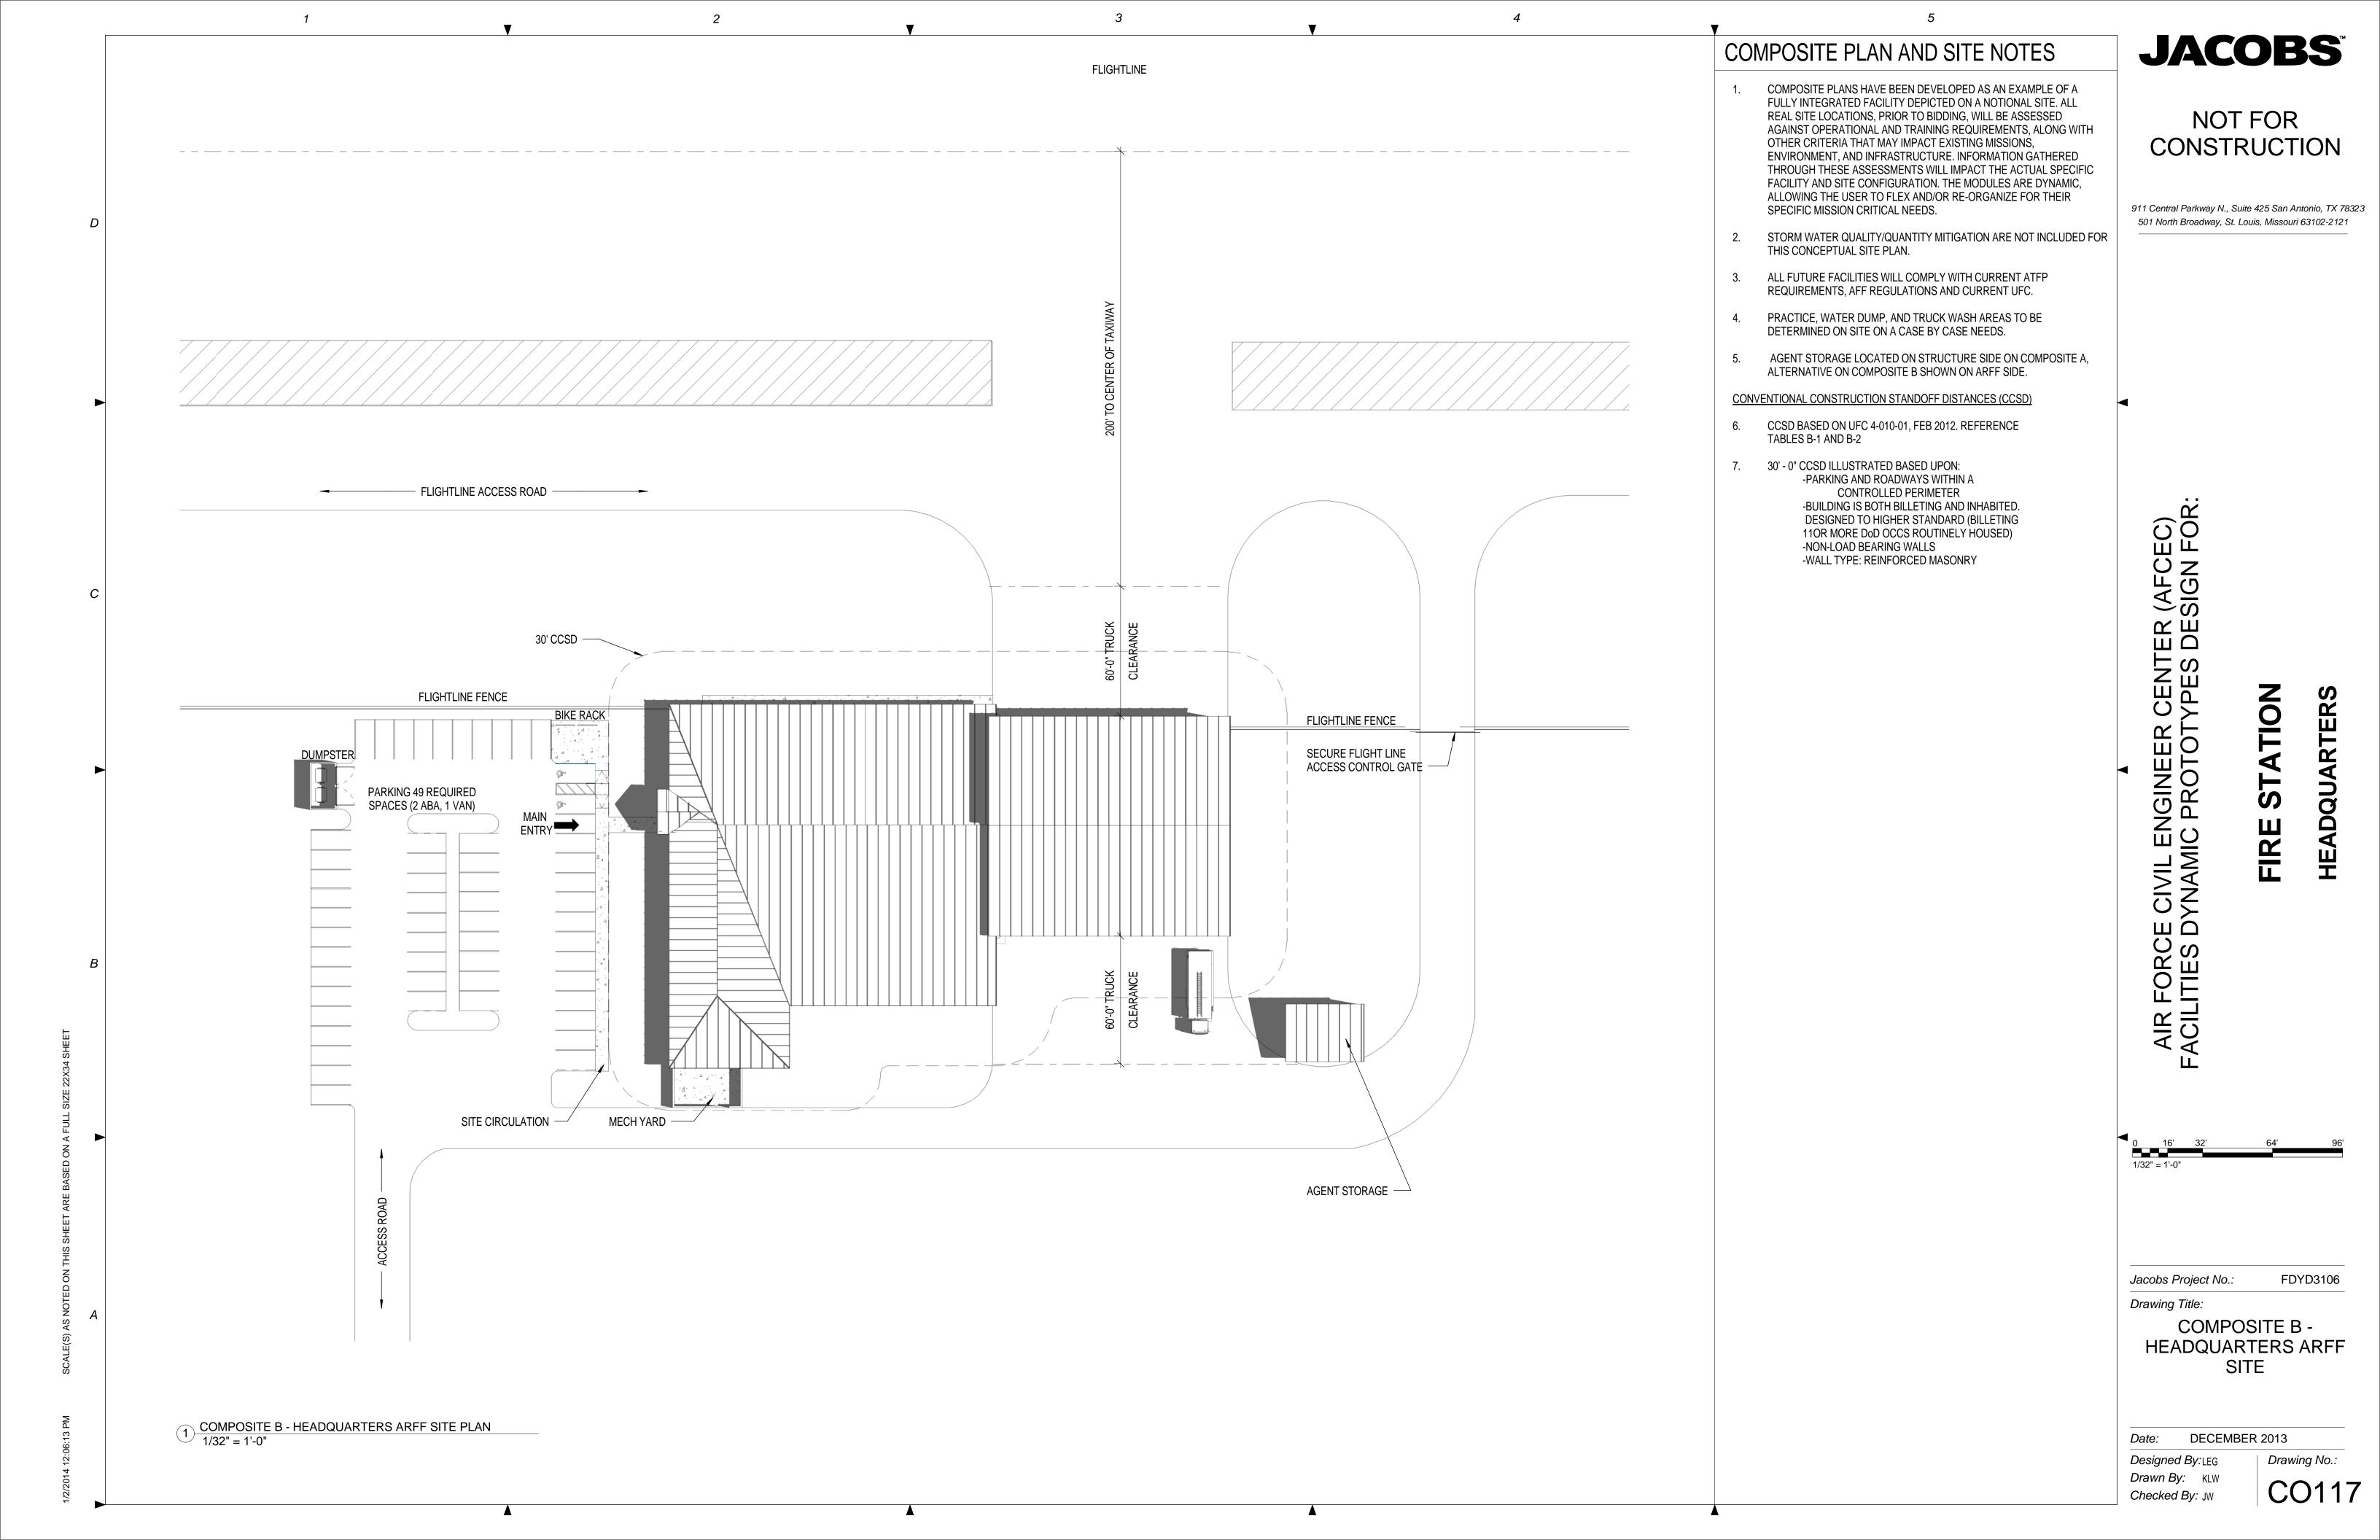
Drawing Title:

COMPOSITE B -**HEADQUARTERS ARFF** PROGRAM AND PERSPECTIVES

DECEMBER 2013

Designed By:LEG Drawn By: KLW Checked By: JW

Drawing No.:







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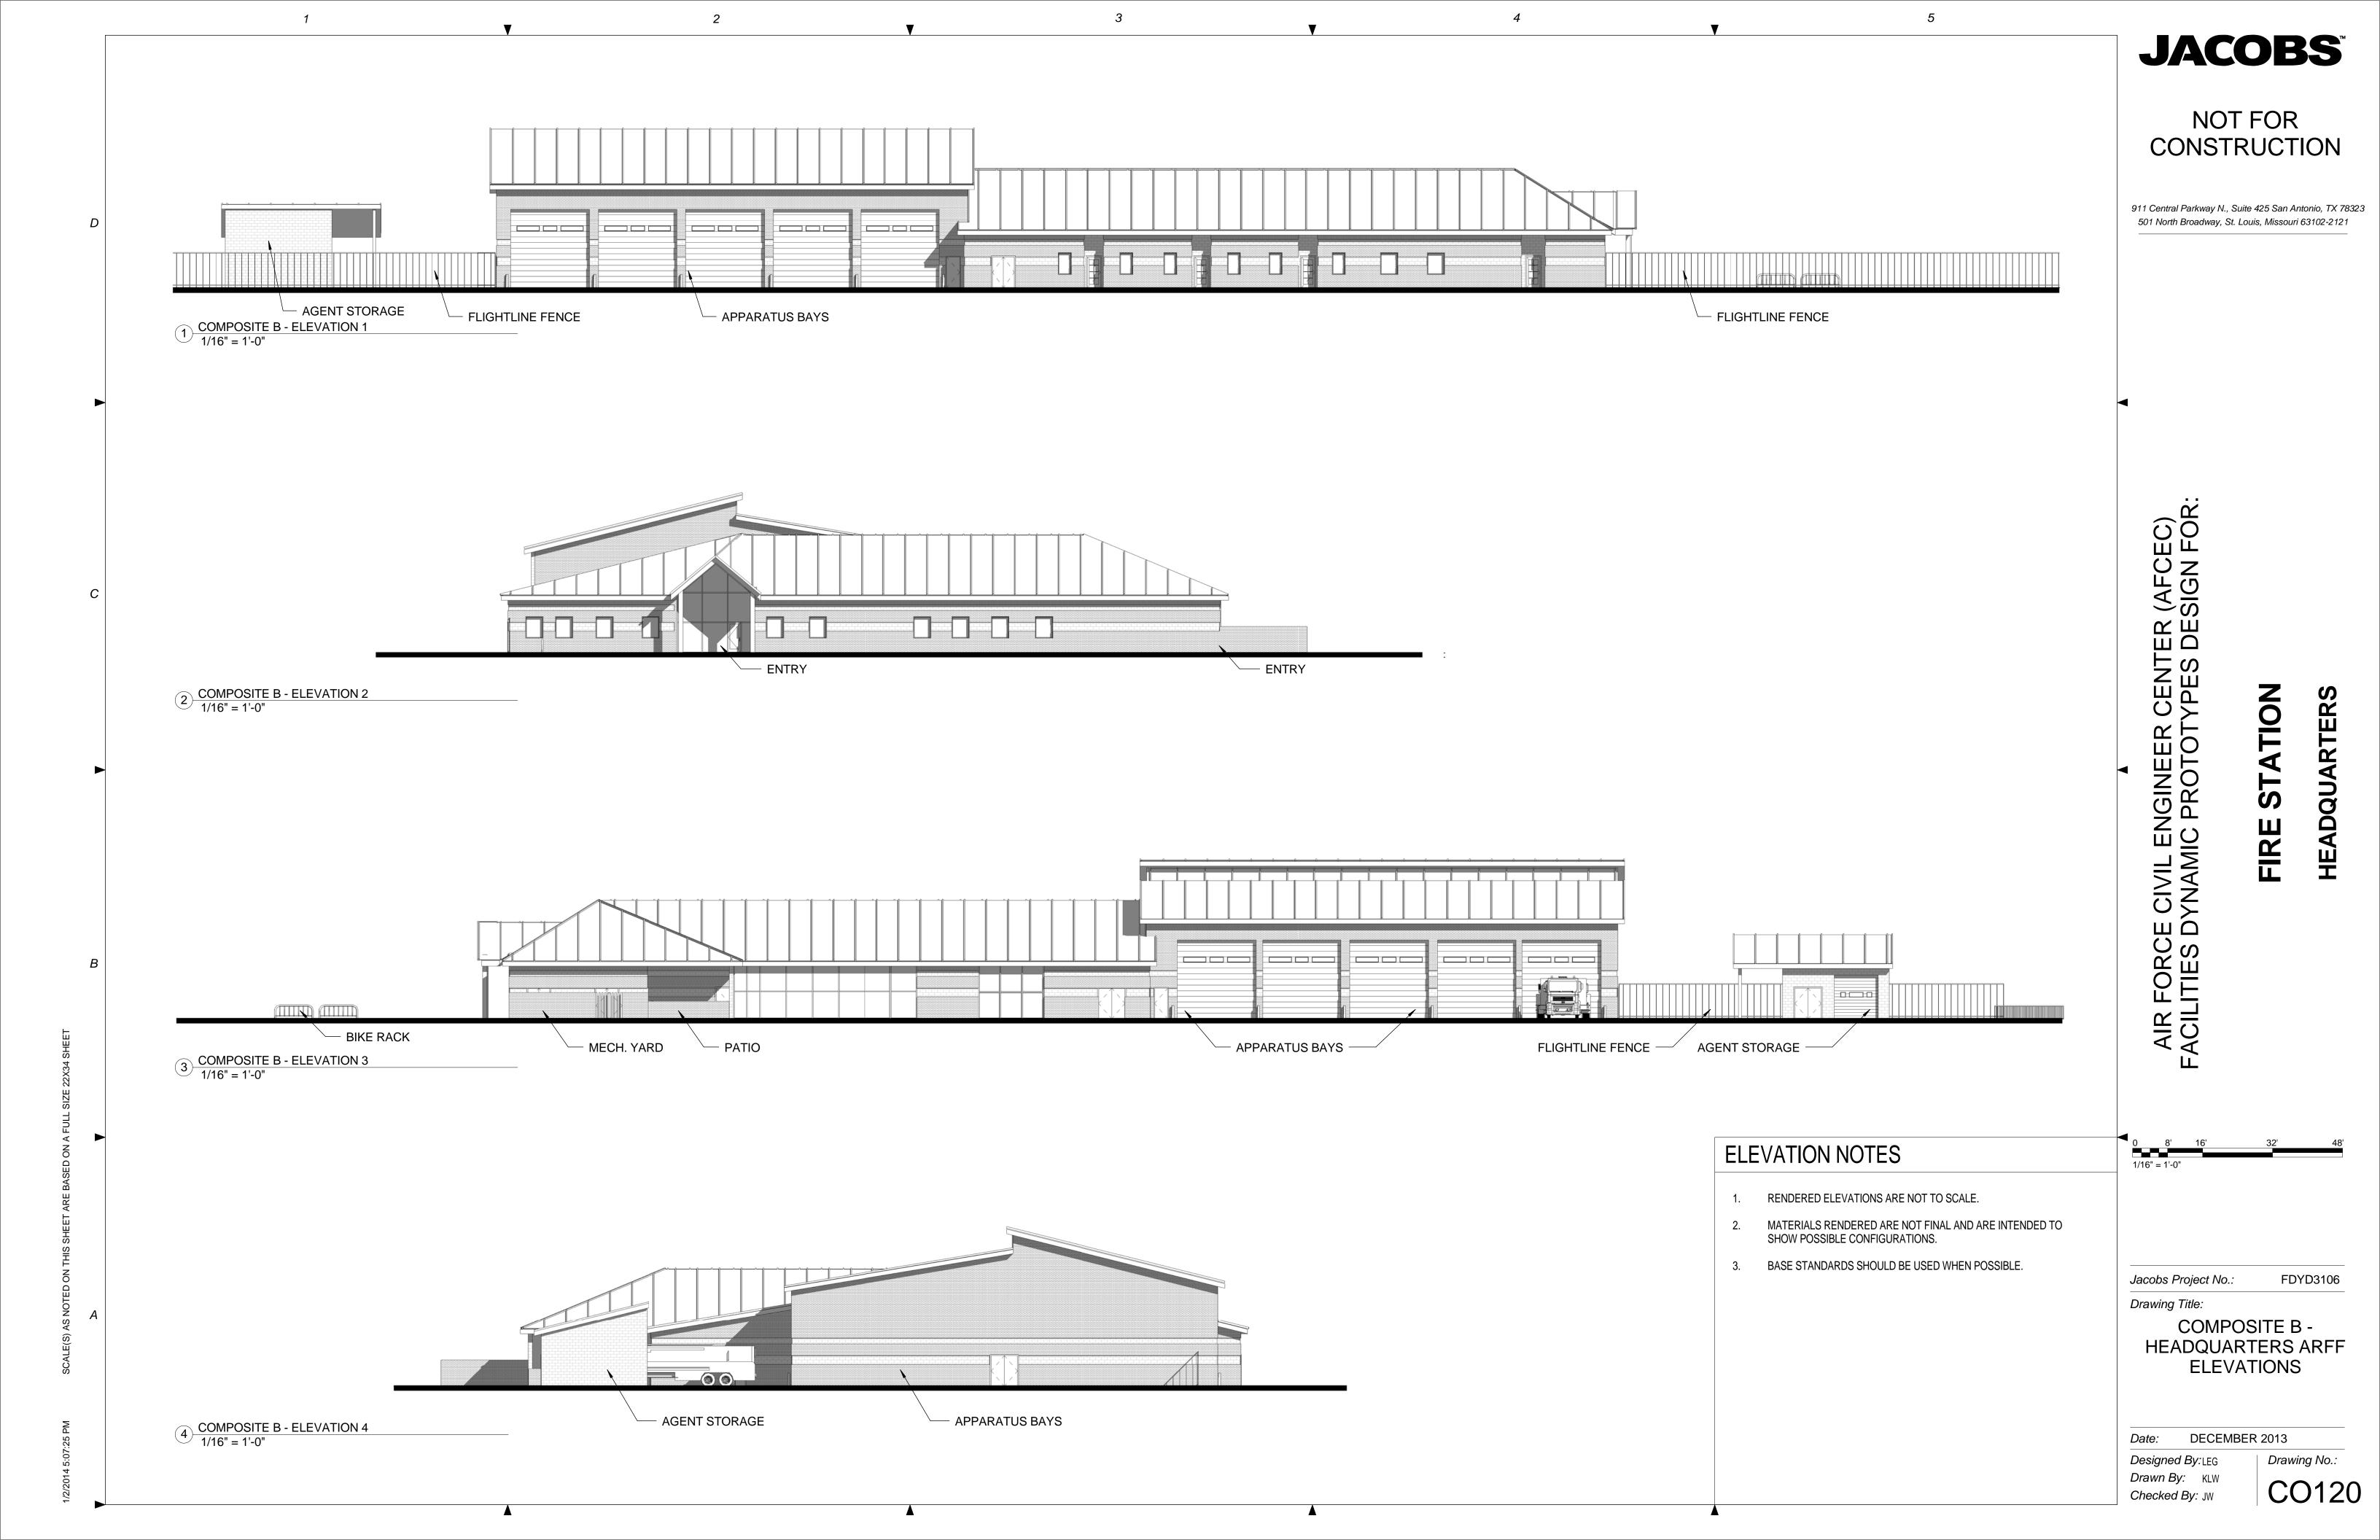
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FDYD3106

ARTERS

COMPOSITE B -**HEADQUARTERS ARFF**

> Drawing No.: CO119



Prototype Fire Station - HQ/Main Structural - Composite A

3 Structural, 0 ARFF Companies with 12 Responders

REQUIREMENTS FC Planning Template (Nov 2011)

COMMENTS

SM (Itemized) SF SF Delta (SF) Delta (%) MAINTENANCE & APPARATUS AREA 521.7 Apparatus Bay 6,415 Small Vehicle (two per bay, if needed) Apparatus Bays Medium Structural Large Structural Medium ARFF Large ARFF EMS Storage - Closet Equipment Wash / Disinfection Fire Extinguisher Inspection HAZMAT / CBRN Equipment Storage Hose Storage Infectious Control Non-Flightline Fire Extinguishing Maintenance and Storage PPE Gear Storage Protective Clothing Laundry -4.0% SCBA Compressor Room SCBA Maintenance Room Spare PPE Gear Storage 20.3% Work Room / Equipment Maintenance Agent Storage (Structural) SUBTOTAL MAINTENANCE. & APPARATUS ARE. 7,873 657.0 7,072 801 11.3% DAY ROOM & RESIDENTIAL AREA Day Room Combination of dining, kitchen, and living 10.0% One workstation for every three Responders Day Hoteling Stations 57.2% Calculated at half area Dorm Rooms Dorm Rooms 120.4 1,296 Bathrooms / Showers / Changing - Female Responders Lavatories Water Closets Showers Bathrooms / Showers / Changing - Male Responders -7.2% Lavatories 2 Water Closet(s), (2) Urinal(s) Water Closets / Urinals Showers 13.4 Laundry Room COMPOSITE A - HEADQUARTERS STRUCTURAL ENTRY Fitness Room 66.9 1 PERSPECTIVE Recreation Recreation Room 33.4 343 SUBTOTAL DAY ROOM & RESIDENTIAL AREA 449.3 4,836 5,010 174 3.6% TRAINING & ADMINISTRATIVE AREA Lobby Area Main Entry Vestibule Admin & Training Restrooms 20.2% Female Lavatories Female Water Closets Male Lavatories 1) Water Closet(s), (1) Urinal(s) Male Water Closets / Urinals Administration & Training Break Room Administration Assistant 17.2% Assistant Chief / Shift Supervisor 0.0% Asst. Chief of Operations Assistant Chief of Fire Prevention Admin and Assistant Chief of Operations / Shift Supervisor's Dorm Room Offices Chief's / Supervisor's Bathroom 10.0% 1) Lavatory, (1) Shower, (1) Water Closet Chief's Conference Room Deputy Chief's Office Fire Chief's Dorm Room 22.0% Fire Chief's Office -0.8% General Administration Storage HAZMAT / Safety Office Inspector's Office(s) / Workstation(s) Station Chief Office / Watch Desk Station Chief/ Station Capt. Computer Training / Testing Room Training and Training Officer Office 3.0% Asst. Chief of Training Testing Training Room 10.4% Training Room Storage Logistics Office Logistics Storage Air Force Reserve and Active Duty Mobility / Deployment Gear Stor. Air Force Reserve Firefighter PPE Gear -0.4% 0 SF / Reservist Air Force Reserve Supervisor Air Force Reserve Workstations SUBTOTAL TRAINING & ADMINSTRATIVE ARE. 3,995 342.1 313 8.5% MERGENCY CONTROL CENTER (ECC ECC Dispatcher ECC IT Room ECC ECC Kitchenette ECC Restroom SUBTOTAL E.C.C. AREA 324 FIRE STATION NET ASSIGNED FLOOR AREA 1,478.0 15,910 17,201 1,291 8.1% INFRASTRUCTURE Facility Maint. Custodial /2% of Net Assigned Area Electrical Rooms 2% of Net Assigned Area Mechanical / Mechanical Room - Admin Area 59.8% Based upon Conditioned Area Electrical Mechanical Room - Responders Area Based upon Conditioned Area Telecomm / IT sed on number of Structural and/or ARFF Cos. SUBTOTAL INFRASTRUCTURE AREA 119.8 1,289 1,193 -96 -7.5% FIRE STATION NET FUNCTIONAL AREA 1,597.8 17,199 18,394 1,195 6.9% NON-FUNCTION SPACE 5% of Net Assigned Area Circulation Corridors, Halls, and other Interior Circulation 98 0.0% 1,403 110.2% Entries Covered Exterior Entries Calculated at half area Walls Interior Partitions and Walls 8% of Net Assigned Area SUBTOTAL NON-FUNCTION AREA 5,407 1,748 47.8% TOTAL FIRE STATION GROSS AREA 1,937.8 20,858 23,801 2,943 14.1% FIRE STATION DESIGN EFFICIENCY 76% 72% PREDESIGN AREA MATRIX COMPOSITE A - HEADQUARTERS STRUCTURAL OVERALL PERSPECTIVE

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AMIC PROTOTYPES DESIGN FOR

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JARTER

Jacobs Project No.:

Drawing Title:

COMPOSITE A -**HEADQUARTERS**

STRUCTURAL PROGRAM AND PERSPECTIVES

DECEMBER 2013

Designed By:LEG Drawn By: KLW Checked By: JW

Drawing No.:

COMPOSITE PLAN AND SITE NOTES

COMPOSITE PLANS HAVE BEEN DEVELOPED AS AN EXAMPLE OF A FULLY INTEGRATED FACILITY DEPICTED ON A NOTIONAL SITE. ALL REAL SITE LOCATIONS, PRIOR TO BIDDING, WILL BE ASSESSED AGAINST OPERATIONAL AND TRAINING REQUIREMENTS, ALONG WITH OTHER CRITERIA THAT MAY IMPACT EXISTING MISSIONS, ENVIRONMENT, AND INFRASTRUCTURE. INFORMATION GATHERED THROUGH THESE ASSESSMENTS WILL IMPACT THE ACTUAL SPECIFIC FACILITY AND SITE CONFIGURATION. THE MODULES ARE DYNAMIC, ALLOWING THE USER TO FLEX AND/OR RE-ORGANIZE FOR THEIR SPECIFIC MISSION CRITICAL NEEDS.

STORM WATER QUALITY/QUANTITY MITIGATION ARE NOT INCLUDED FOR

ALL FUTURE FACILITIES WILL COMPLY WITH CURRENT ATFP REQUIREMENTS, AFF REGULATIONS AND CURRENT UFC.

PRACTICE, WATER DUMP, AND TRUCK WASH AREAS TO BE DETERMINED ON SITE ON A CASE BY CASE NEEDS.

AGENT STORAGE LOCATED ON STRUCTURE SIDE ON COMPOSITE A, ALTERNATIVE ON COMPOSITE B SHOWN ON ARFF SIDE.

CONVENTIONAL CONSTRUCTION STANDOFF DISTANCES (CCSD)

CCSD BASED ON UFC 4-010-01, FEB 2012. REFERENCE

30' - 0" CCSD ILLUSTRATED BASED UPON: -PARKING AND ROADWAYS WITHIN A CONTROLLED PERIMETER -BUILDING IS BOTH BILLETING AND INHABITED. DESIGNED TO HIGHER STANDARD (BILLETING 11OR MORE DoD OCCS ROUTINELY HOUSED) -NON-LOAD BEARING WALLS -WALL TYPE: REINFORCED MASONRY

JACOBS

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CENTER (AFCEC) YPES DESIGN FOR

NOL

RTER

FDYD3106 Jacobs Project No.:

Drawing Title:

COMPOSITE A -**HEADQUARTERS** STRUCTURAL SITE

DECEMBER 2013

Designed By:LEG Drawn By: KLW Checked By: JW

CO122

Drawing No.:

APPARATUS BAYS

ADMINISTRATION

APPARATUS SUPPORT

TRAINING

AGENT STORAGE

TESTING

DAYROOM

RESERVE

FITNESS

LOGISTICS

DORM

DISPATCH

(ECC)

THE SPECIFIC FACILITY.

Jacobs Project No.: Drawing Title:

LOBBY/ VESTIBULE

RESPONDER RESTROOM

BREAK

ROOM

ADMIN RESTROOM

HOTELING

LAUNDRY

RECREATION

COMPOSITE A -HEADQUARTERS

JACOBS

STRUCTURAL OVERALL FLOOR PLAN

DECEMBER 2013 Date:

Designed By:LEG Drawn By: KLW Checked By: JW

Drawing No.: CO123



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AIR FORCE CIVIL ENGINEER CENTER (AFCEC) FACILITIES DYNAMIC PROTOTYPES DESIGN FOR

STATION


FDYD3106 Jacobs Project No.:

COMPOSITE A -**HEADQUARTERS** STRUCTURAL ENLARGED FLOOR PLANS

DECEMBER 2013

Designed By: LEG Drawn By: KLW Checked By: JW


Drawing No.: CO124

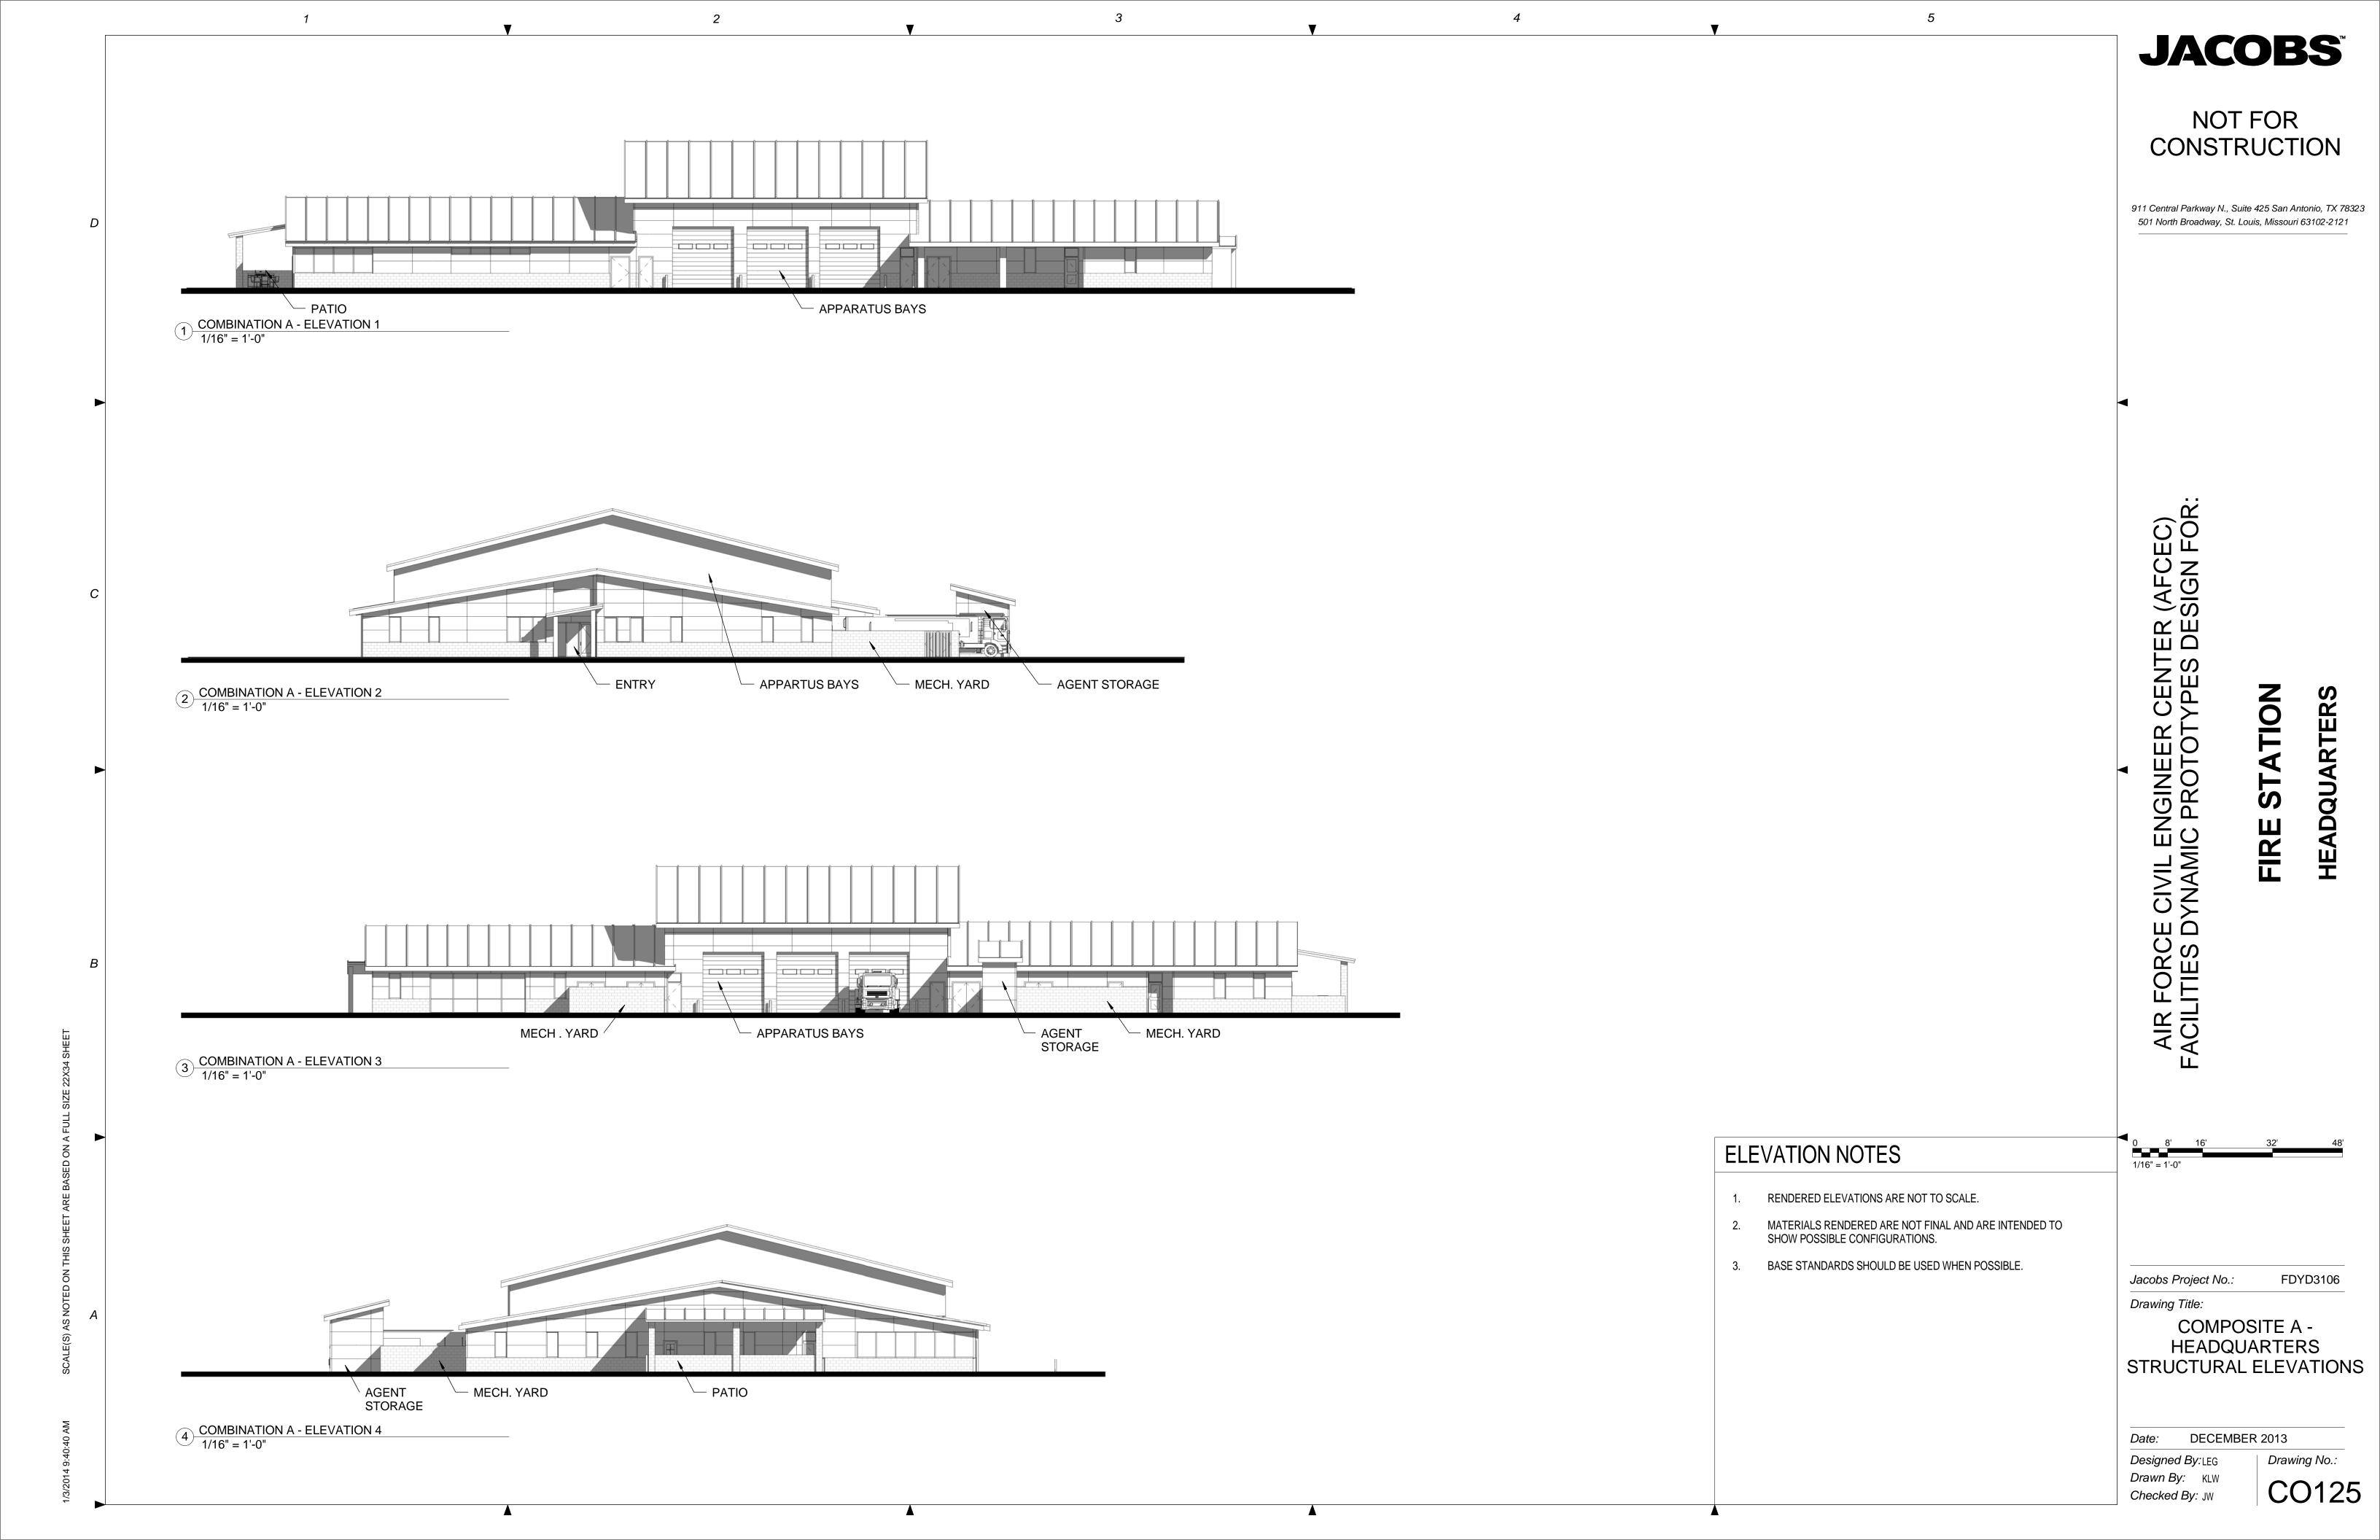

SUBTOTAL E.C.C. AREA 341 21 6.6% 29.7 FIRE STATION NET ASSIGNED FLOOR AREA 1,489.7 16,035 159 1.0% 16,194 INFRASTRUCTURE Facility Maint. Custodial Mechanical / Electrical Rooms -45.8% 2% of Net Assigned Area Electrical Mechanical Room - Admin Area Based upon Conditioned Area Base IT / Comms Room (s) Telecomm / IT 119.8 1,289 1,031 -258 -20.0% 1,609.4 17,324 17,225 -100 -0.6% FIRE STATION NET FUNCTIONAL AREA NON-FUNCTION SPACE Circulation Corridors, Halls, and other Interior Circulation 5% of Net Assigned Area Entries Covered Exterior Entries
Walls Interior Partitions and Walls Calculated at half area 8% of Net Assigned Area SUBTOTAL NON-FUNCTION AREA 845 22.9% 342.6 4,533 3,688 Drawing Title: 745 3.5% TOTAL FIRE STATION GROSS AREA 1,952.0 21,012 21,757 FIRE STATION DESIGN EFFICIENCY 76% 74% PREDESIGN AREA MATRIX COMPOSITE B - HEADQUARTERS STRUCTURAL OVERALL PERSPECTIVE Checked By: JW

COMPOSITE B - HEADQUARTERS STRUCTURAL ENTRY

PERSPECTIVE.

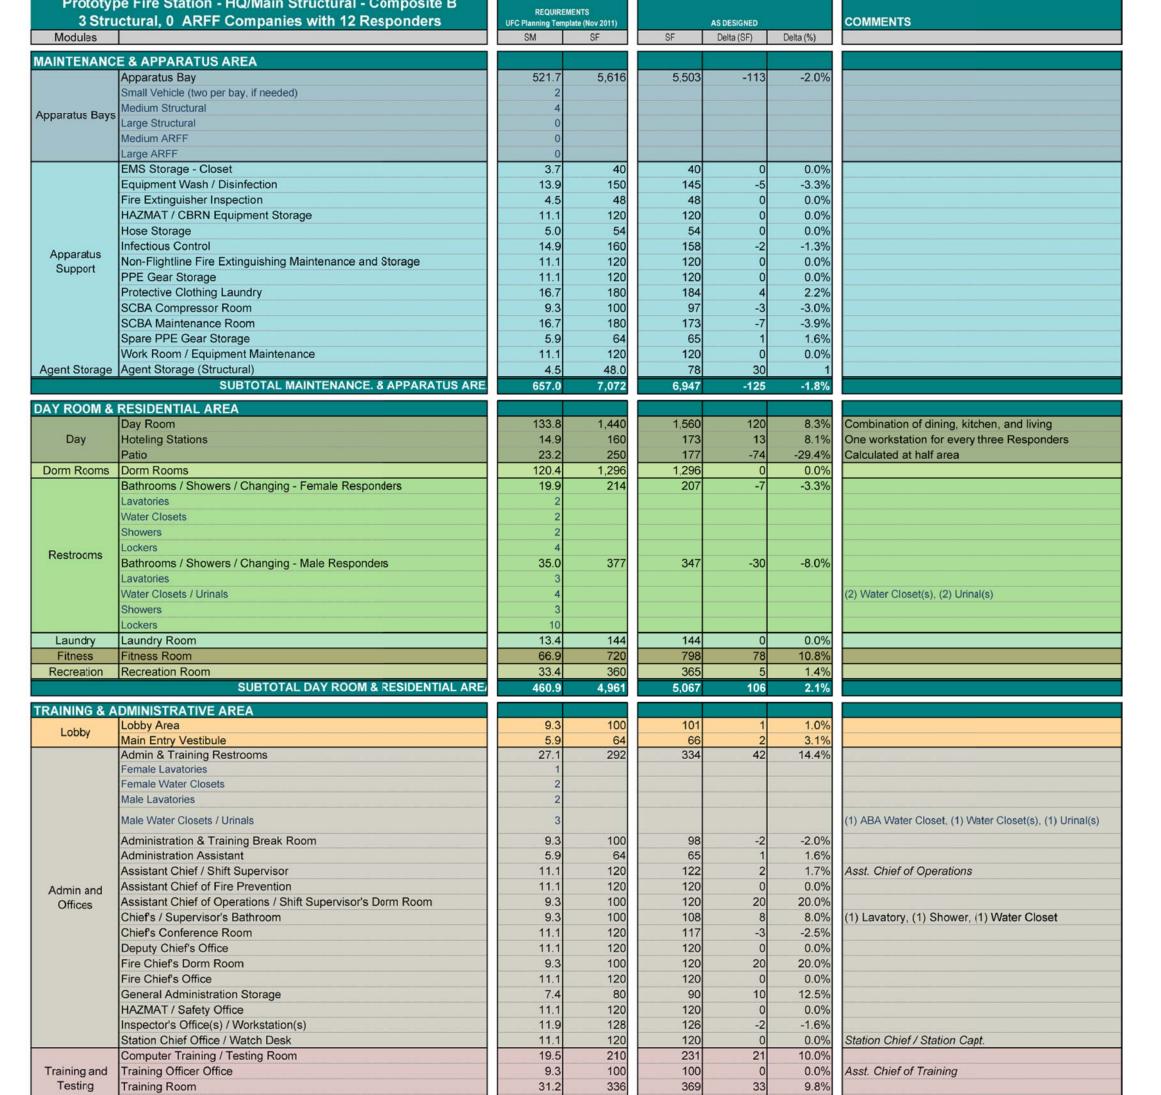

Prototype Fire Station - HQ/Main Structural - Composite B

3 Structural, 0 ARFF Companies with 12 Responders

Training Room Storage Logistics Office

Air Force Reserve Supervisor

Air Force Reserve Firefighter PPE Gear

Air Force Reserve and Active Duty Mobility / Deployment Gear Stor.

Air Force Reserve Workstations
SUBTOTAL TRAINING & ADMINSTRATIVE ARE.

Logistics Storage

EMERGENCY CONTROL CENTER (ECC CC Dispatcher ECC IT Room

ECC Kitchenette

Logistics

ECC

COMMENTS

SF Delta (SF) Delta (%)

-0.8% 10 SF / Reservist 157 4.3%

3,839

342.1

3,682

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CONSTRUCTION

IL ENGINEER CENTER (AFCEC)
AMIC PROTOTYPES DESIGN FOR

MOL

JARTER

Jacobs Project No.:

COMPOSITE B -**HEADQUARTERS** STRUCTURAL PROGRAM AND PERSPECTIVES

DECEMBER 2013

Designed By:LEG Drawn By: KLW

Drawing No.:

2. STORM WATER QUALITY/QUANTITY MITIGATION ARE NOT INCLUDED FOR THIS CONCEPTUAL SITE PLAN.

3. ALL FUTURE FACILITIES WILL COMPLY WITH CURRENT ATFP REQUIREMENTS, AFF REGULATIONS AND CURRENT UFC.

PRACTICE, WATER DUMP, AND TRUCK WASH AREAS TO BE DETERMINED ON SITE ON A CASE BY CASE NEEDS.

5. AGENT STORAGE LOCATED ON STRUCTURE SIDE ON COMPOSITE A, ALTERNATIVE ON COMPOSITE B SHOWN ON ARFF SIDE.

CONVENTIONAL CONSTRUCTION STANDOFF DISTANCES (CCSD)

6. CCSD BASED ON UFC 4-010-01, FEB 2012. REFERENCE TABLES B-1 AND B-2

30' - 0" CCSD ILLUSTRATED BASED UPON:
-PARKING AND ROADWAYS WITHIN A
CONTROLLED PERIMETER
-BUILDING IS BOTH BILLETING AND INHABITED.
DESIGNED TO HIGHER STANDARD (BILLETING
11OR MORE DOD OCCS ROUTINELY HOUSED)
-NON-LOAD BEARING WALLS
-WALL TYPE: REINFORCED MASONRY

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AIR FORCE CIVIL ENGINEER CENTER (AFCEC) FACILITIES DYNAMIC PROTOTYPES DESIGN FOR

NOL

ARTER

0 16' 32' 64' 1/32" = 1'-0"

Jacobs Project No.:

Drawing Title:

COMPOSITE B -HEADQUARTERS STRUCTURAL SITE

Date: DECEMBER 2013

Designed By:LEG
Drawn By: KLW
Checked By: JW

CO127

Drawing No.:

NOT FOR CONSTRUCTION

911 Central Parkway N., Suite 425 San Antonio, TX 78323



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AIR FORCE CIVIL ENGINEER CENTER (AFCEC) FACILITIES DYNAMIC PROTOTYPES DESIGN FOR

STATION

Jacobs Project No.:

COMPOSITE B -**HEADQUARTERS** STRUCTURAL ENLARGED FLOOR PLAN

DECEMBER 2013

Designed By: LEG Drawn By: KLW Checked By: JW

Drawing No.: CO129

