

GENERAL NOTES

1. USE THESE DOCUMENTS IN CONJUNCTION WITH THE STANDARD DESIGN DOCUMENT AND INTERACTIVE PROGRAMMING WORKSHEET.

DRAWING LIST

NUMBER	NAME
C-1	COVER SHEET
A-1	STANDARD DESIGN PLAN
A-2	MODULES A, B, & C PLANS & AXONS
A-3	MODULES D, E, & F PLANS & AXONS

AIR FORCE STANDARD DESIGN CES PEST MANAGEMENT BUILDING



PHASE: PRE-FINAL SUBMITTAL
DATE: MARCH 2018
SCALE: AS INDICATED

**AIR FORCE
CIVIL ENGINEER
CENTER**


CIVIL ENGINEER SQUADRON:
PEST MANAGEMENT
ANY AFB, CONUS
COVER SHEET

SHEET
NUMBER
C-1


MARCH 2018

NOT FOR CONSTRUCTION

MODULE LEGEND

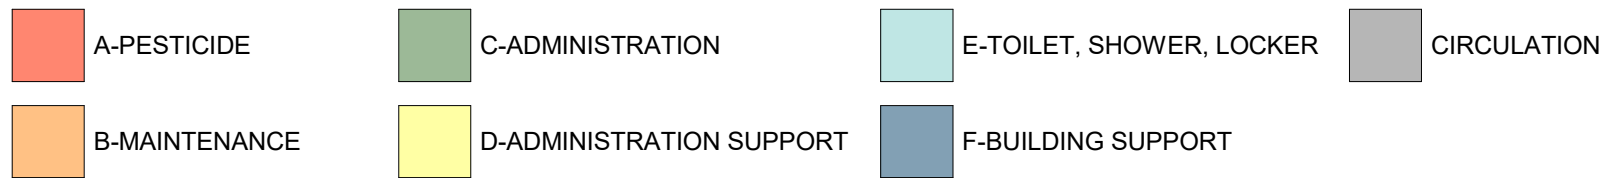

THIS BASIS OF DESIGN CONCEPT FLOOR PLAN IS BASED ON THE APPROVED FUNCTIONAL ADJACENCY DIAGRAM. THE ROOM CRITERIA IS LOCATED IN THE ROOM DATA SHEETS IN THE STANDARD DESIGN DOCUMENT AND THE ROOM SIZES ARE LOCATED IN THE INTERACTIVE PROGRAMMING WORKSHEET. THE OVERALL DIMENSIONS ARE APPROXIMATE AS THE BASIS OF DESIGN CONCEPT PLAN DOES NOT INDICATE STRUCTURAL ELEMENTS, ALL PLUMBING CHASES, MISCELLANEOUS UTILITY ROOMS (MECHANICAL, ELECTRICAL, COMMUNICATIONS) OR WALL THICKNESSES, ETC.

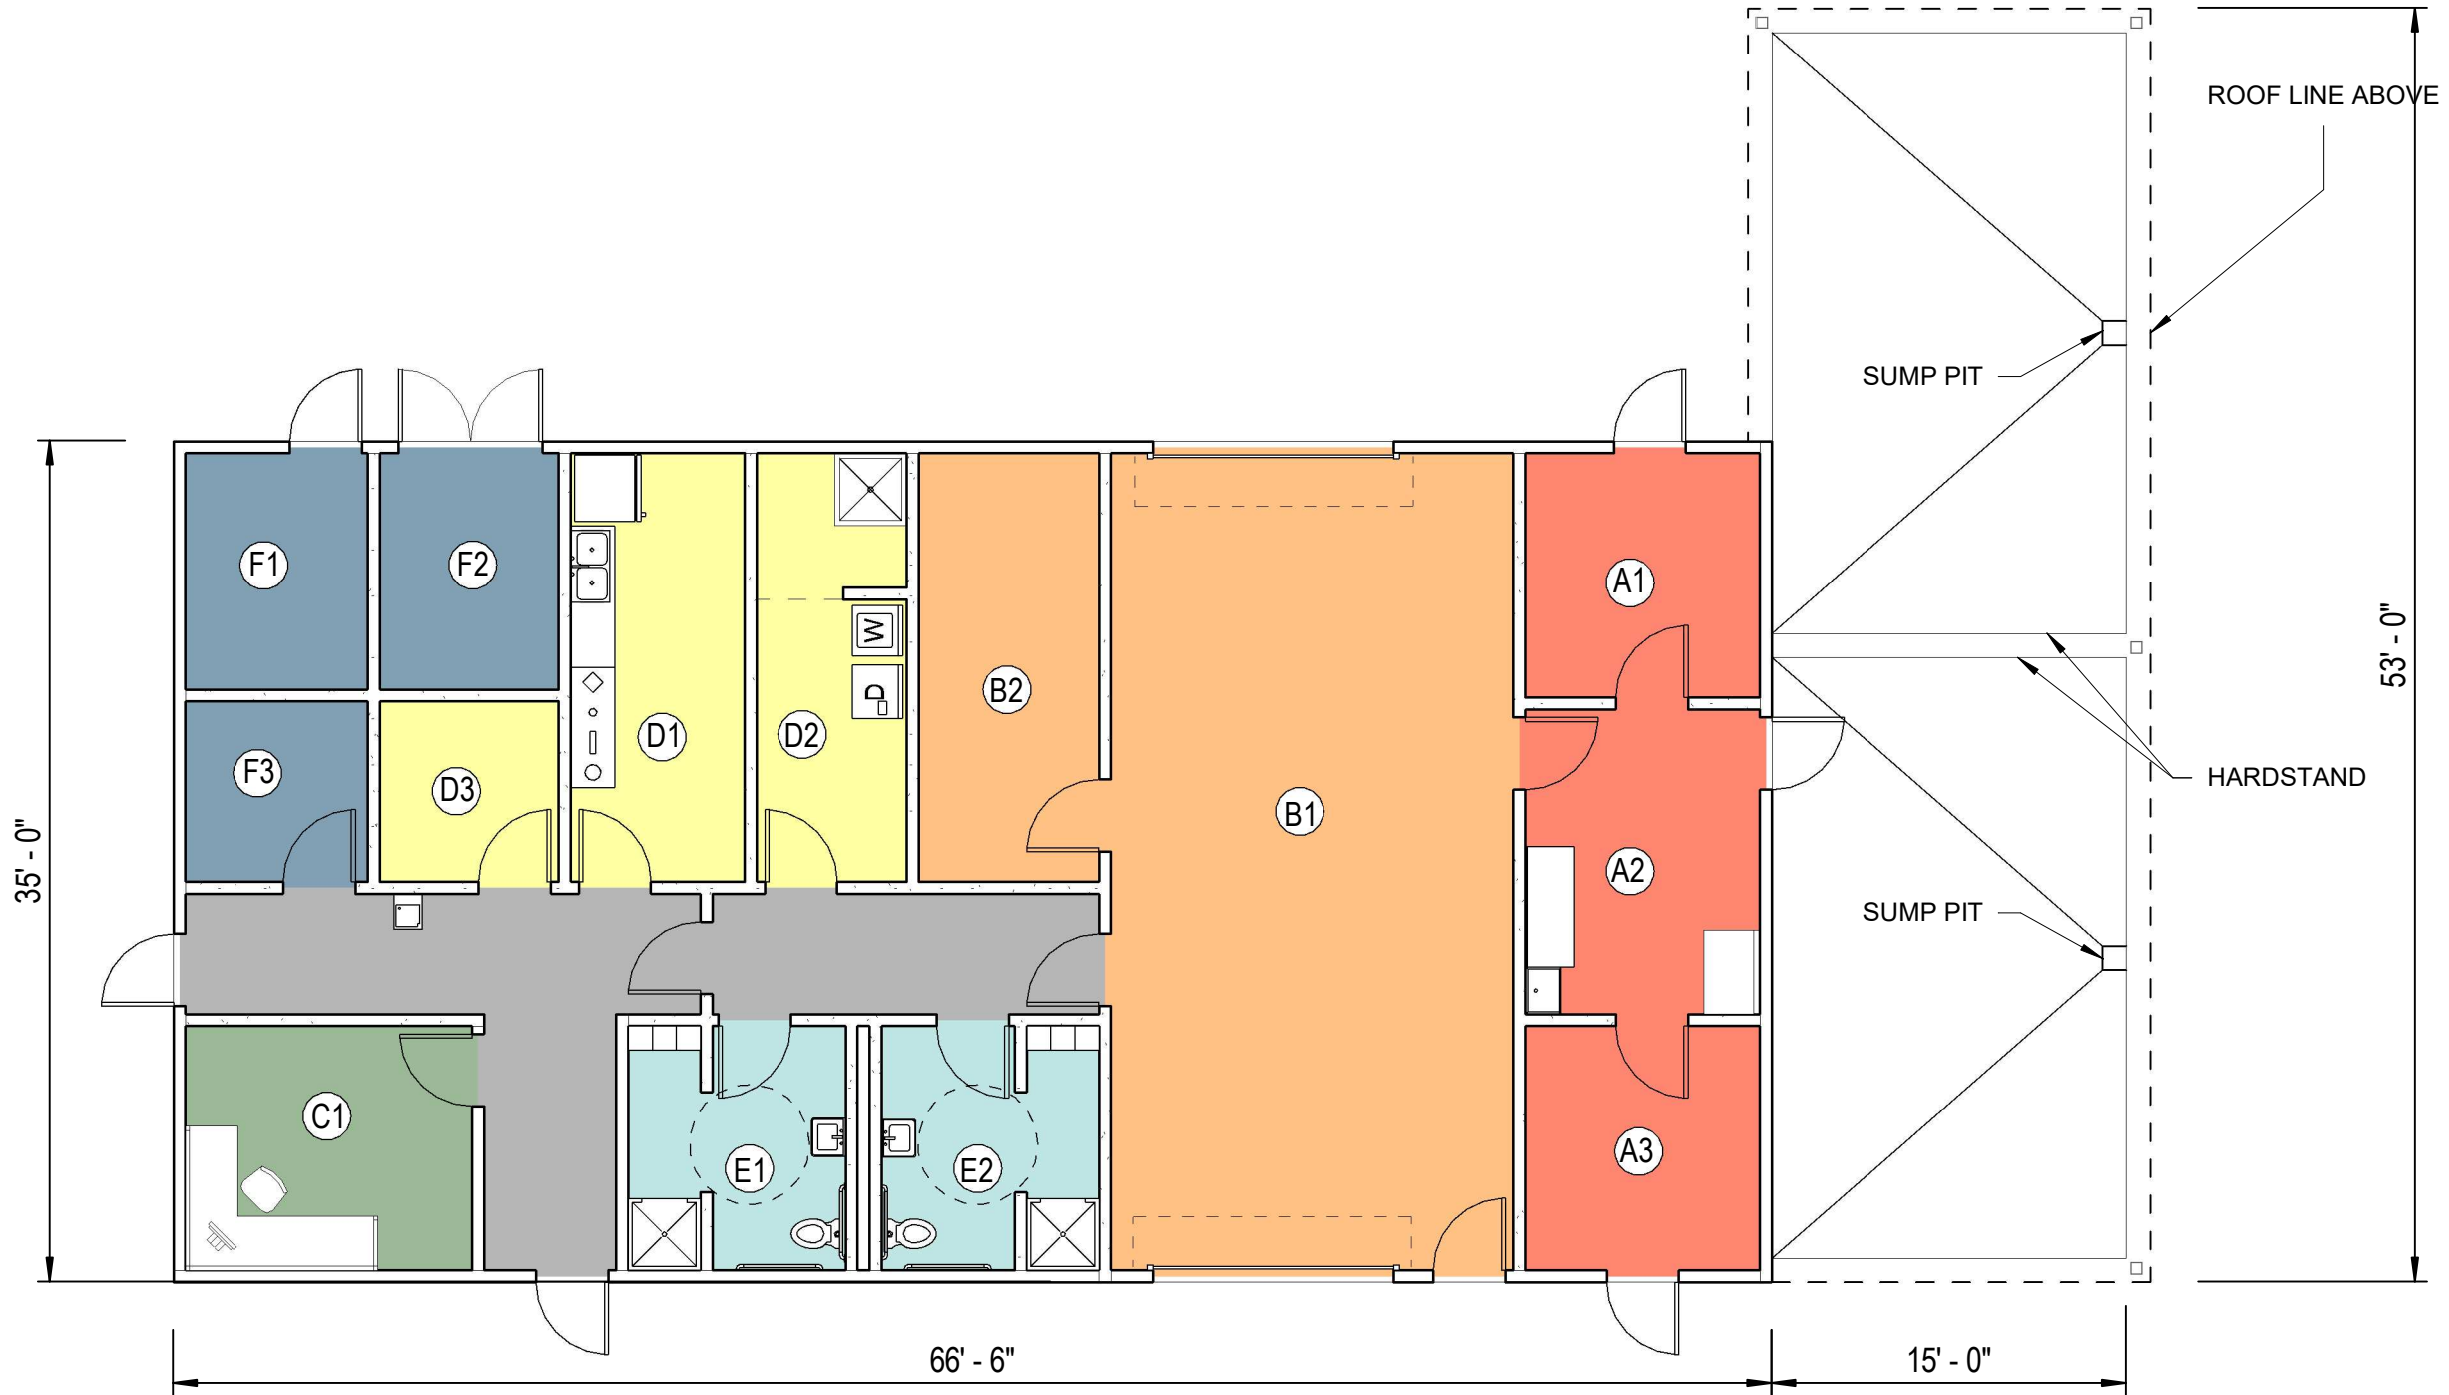


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CIVIL ENGINEER SQUADRON:
PEST MANAGEMENT
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**STANDARD DESIGN
PLAN**

SHEET
NUMBER
A-1



- (A1) INSECTICIDE STORAGE
- (A2) MIXING ROOM
- (A3) HERBICIDE STORAGE

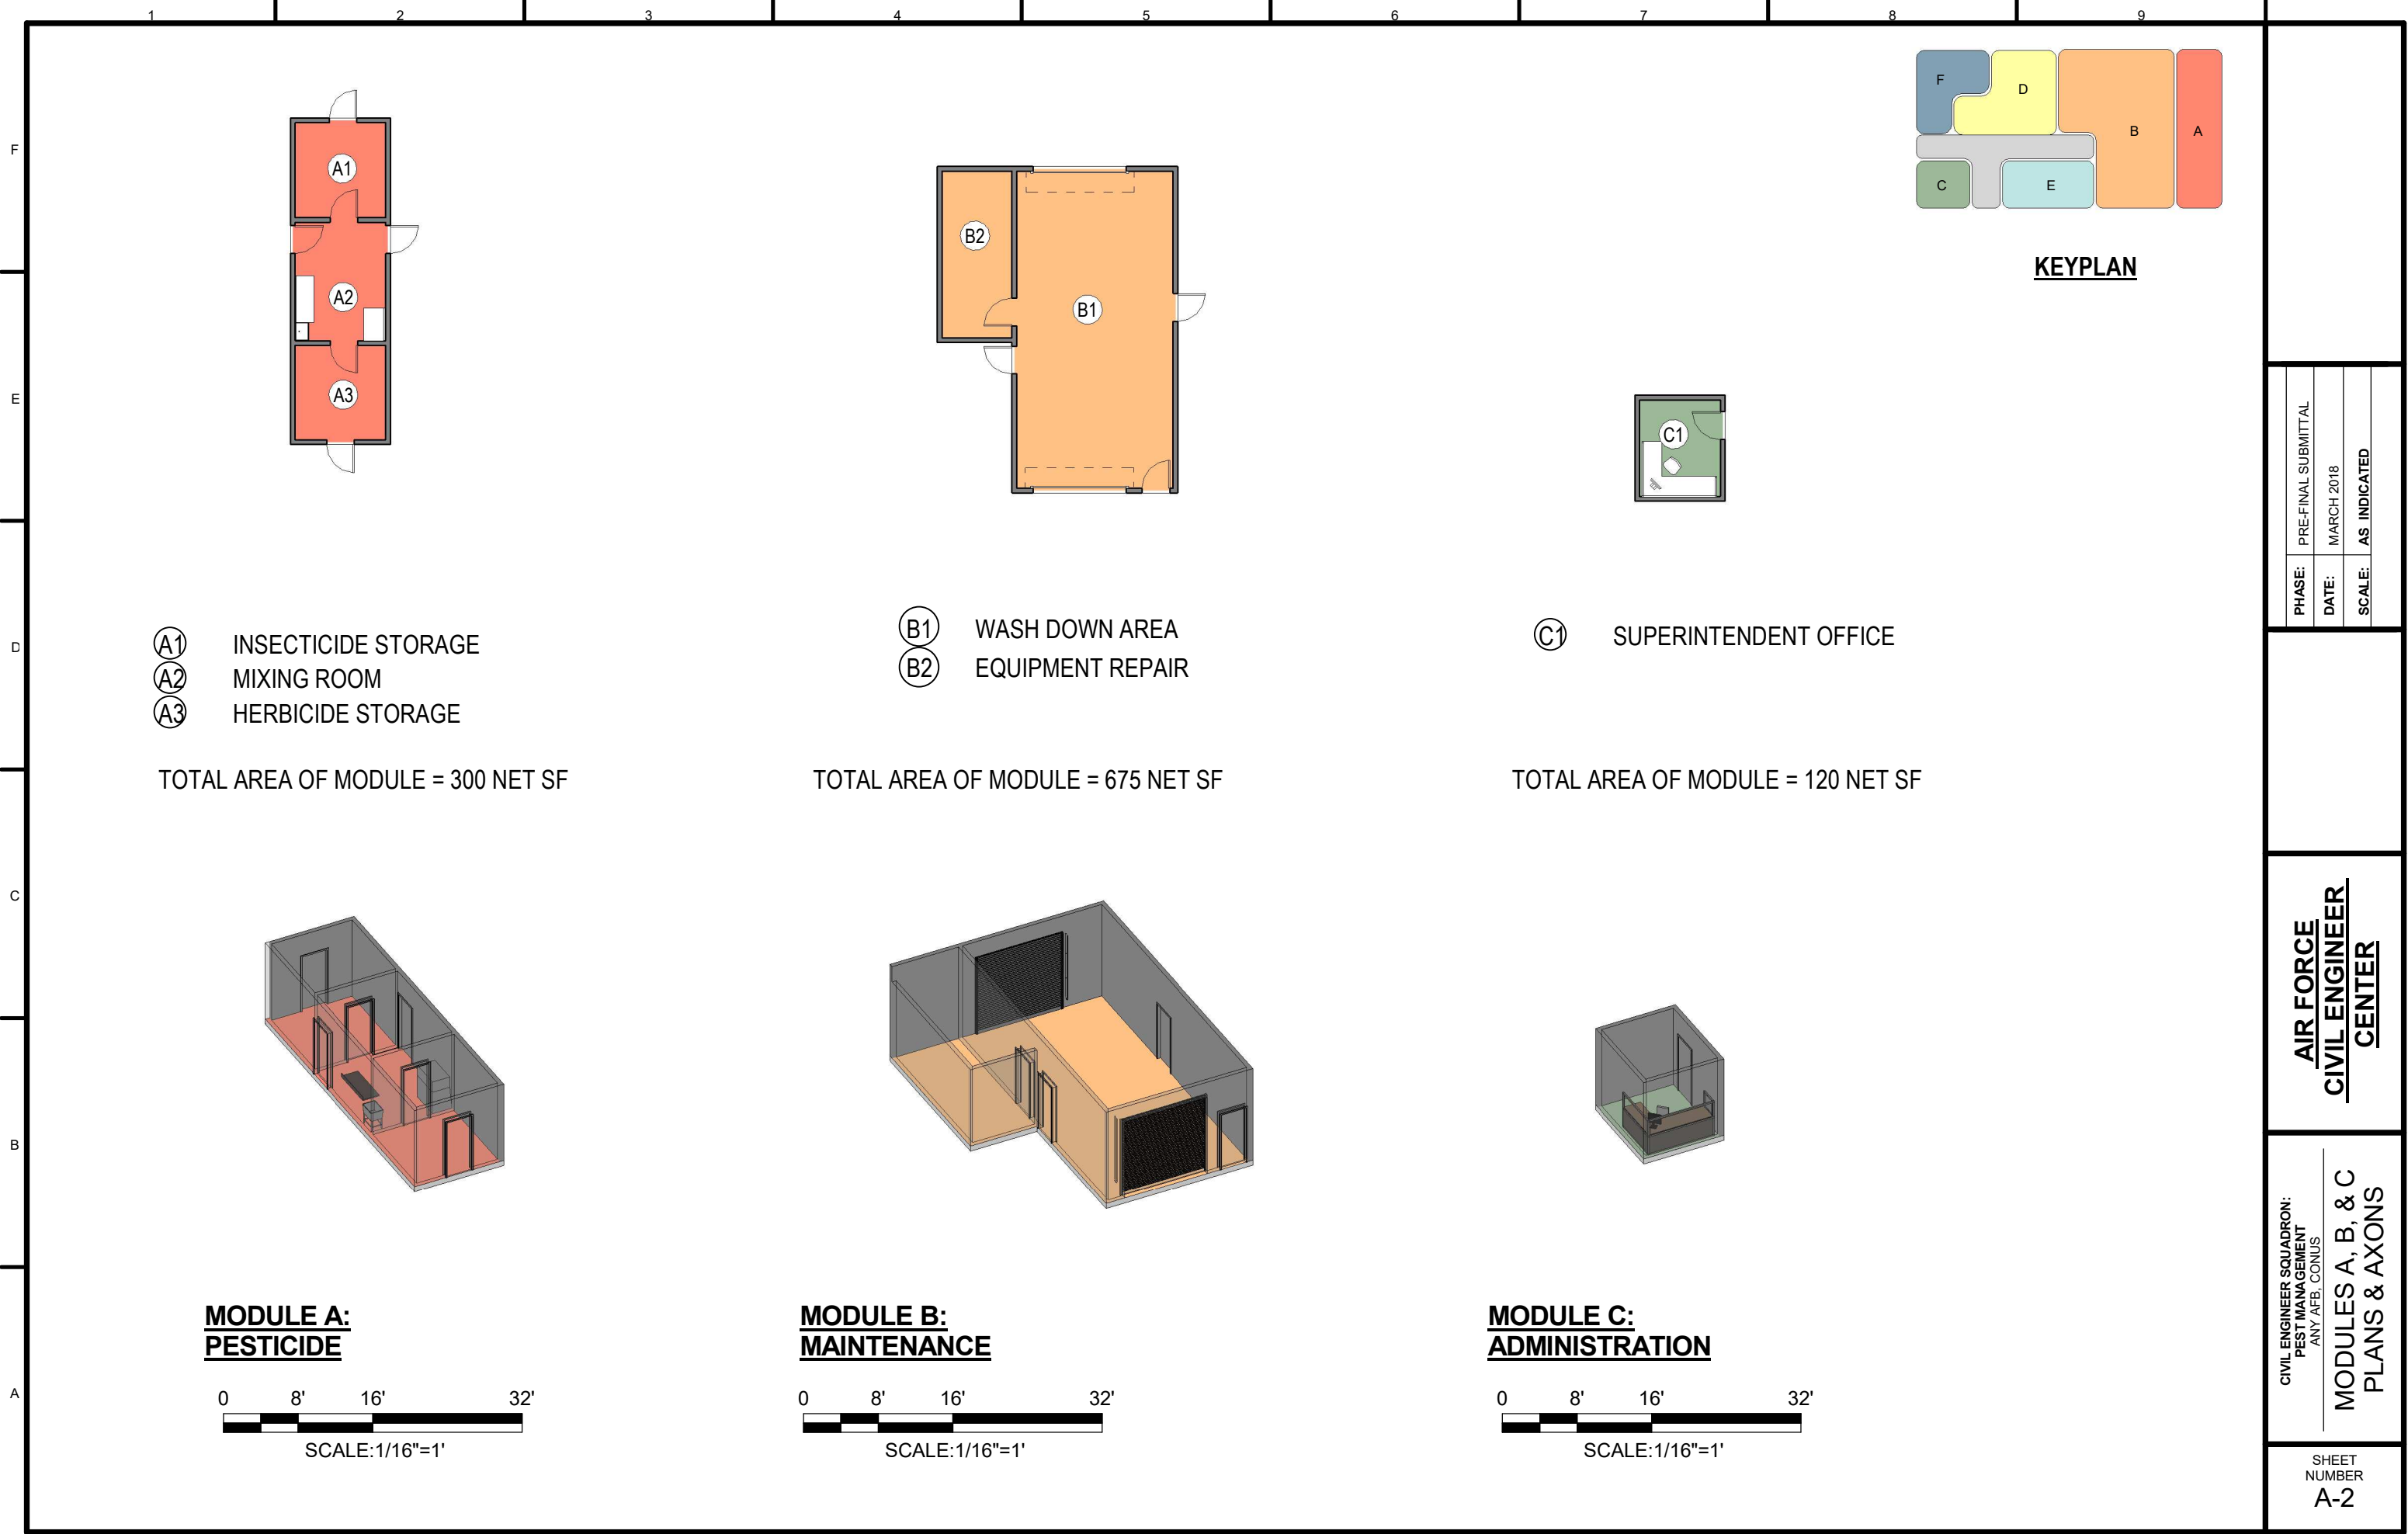TOTAL AREA OF MODULE = 300 NET SF


- (B1) WASH DOWN AREA
- (B2) EQUIPMENT REPAIR

TOTAL AREA OF MODULE = 675 NET SF


- (C1) SUPERINTENDENT OFFICE

TOTAL AREA OF MODULE = 120 NET SF



**MODULE A:
PESTICIDE**

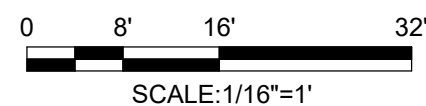

**MODULE B:
MAINTENANCE**

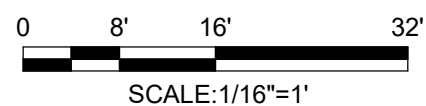

**MODULE C:
ADMINISTRATION**

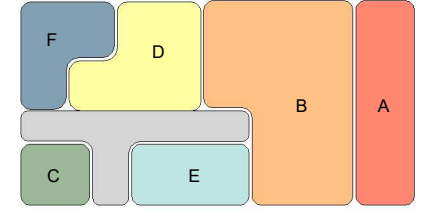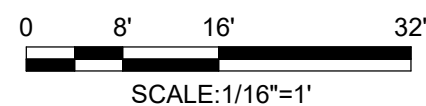


KEYPLAN

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CIVIL ENGINEER SQUADRON:
PEST MANAGEMENT
ANY AFB, CONUS
**MODULES A, B, & C
PLANS & AXONS**

SHEET
NUMBER
A-2



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**AIR FORCE
 CIVIL ENGINEER
 CENTER**

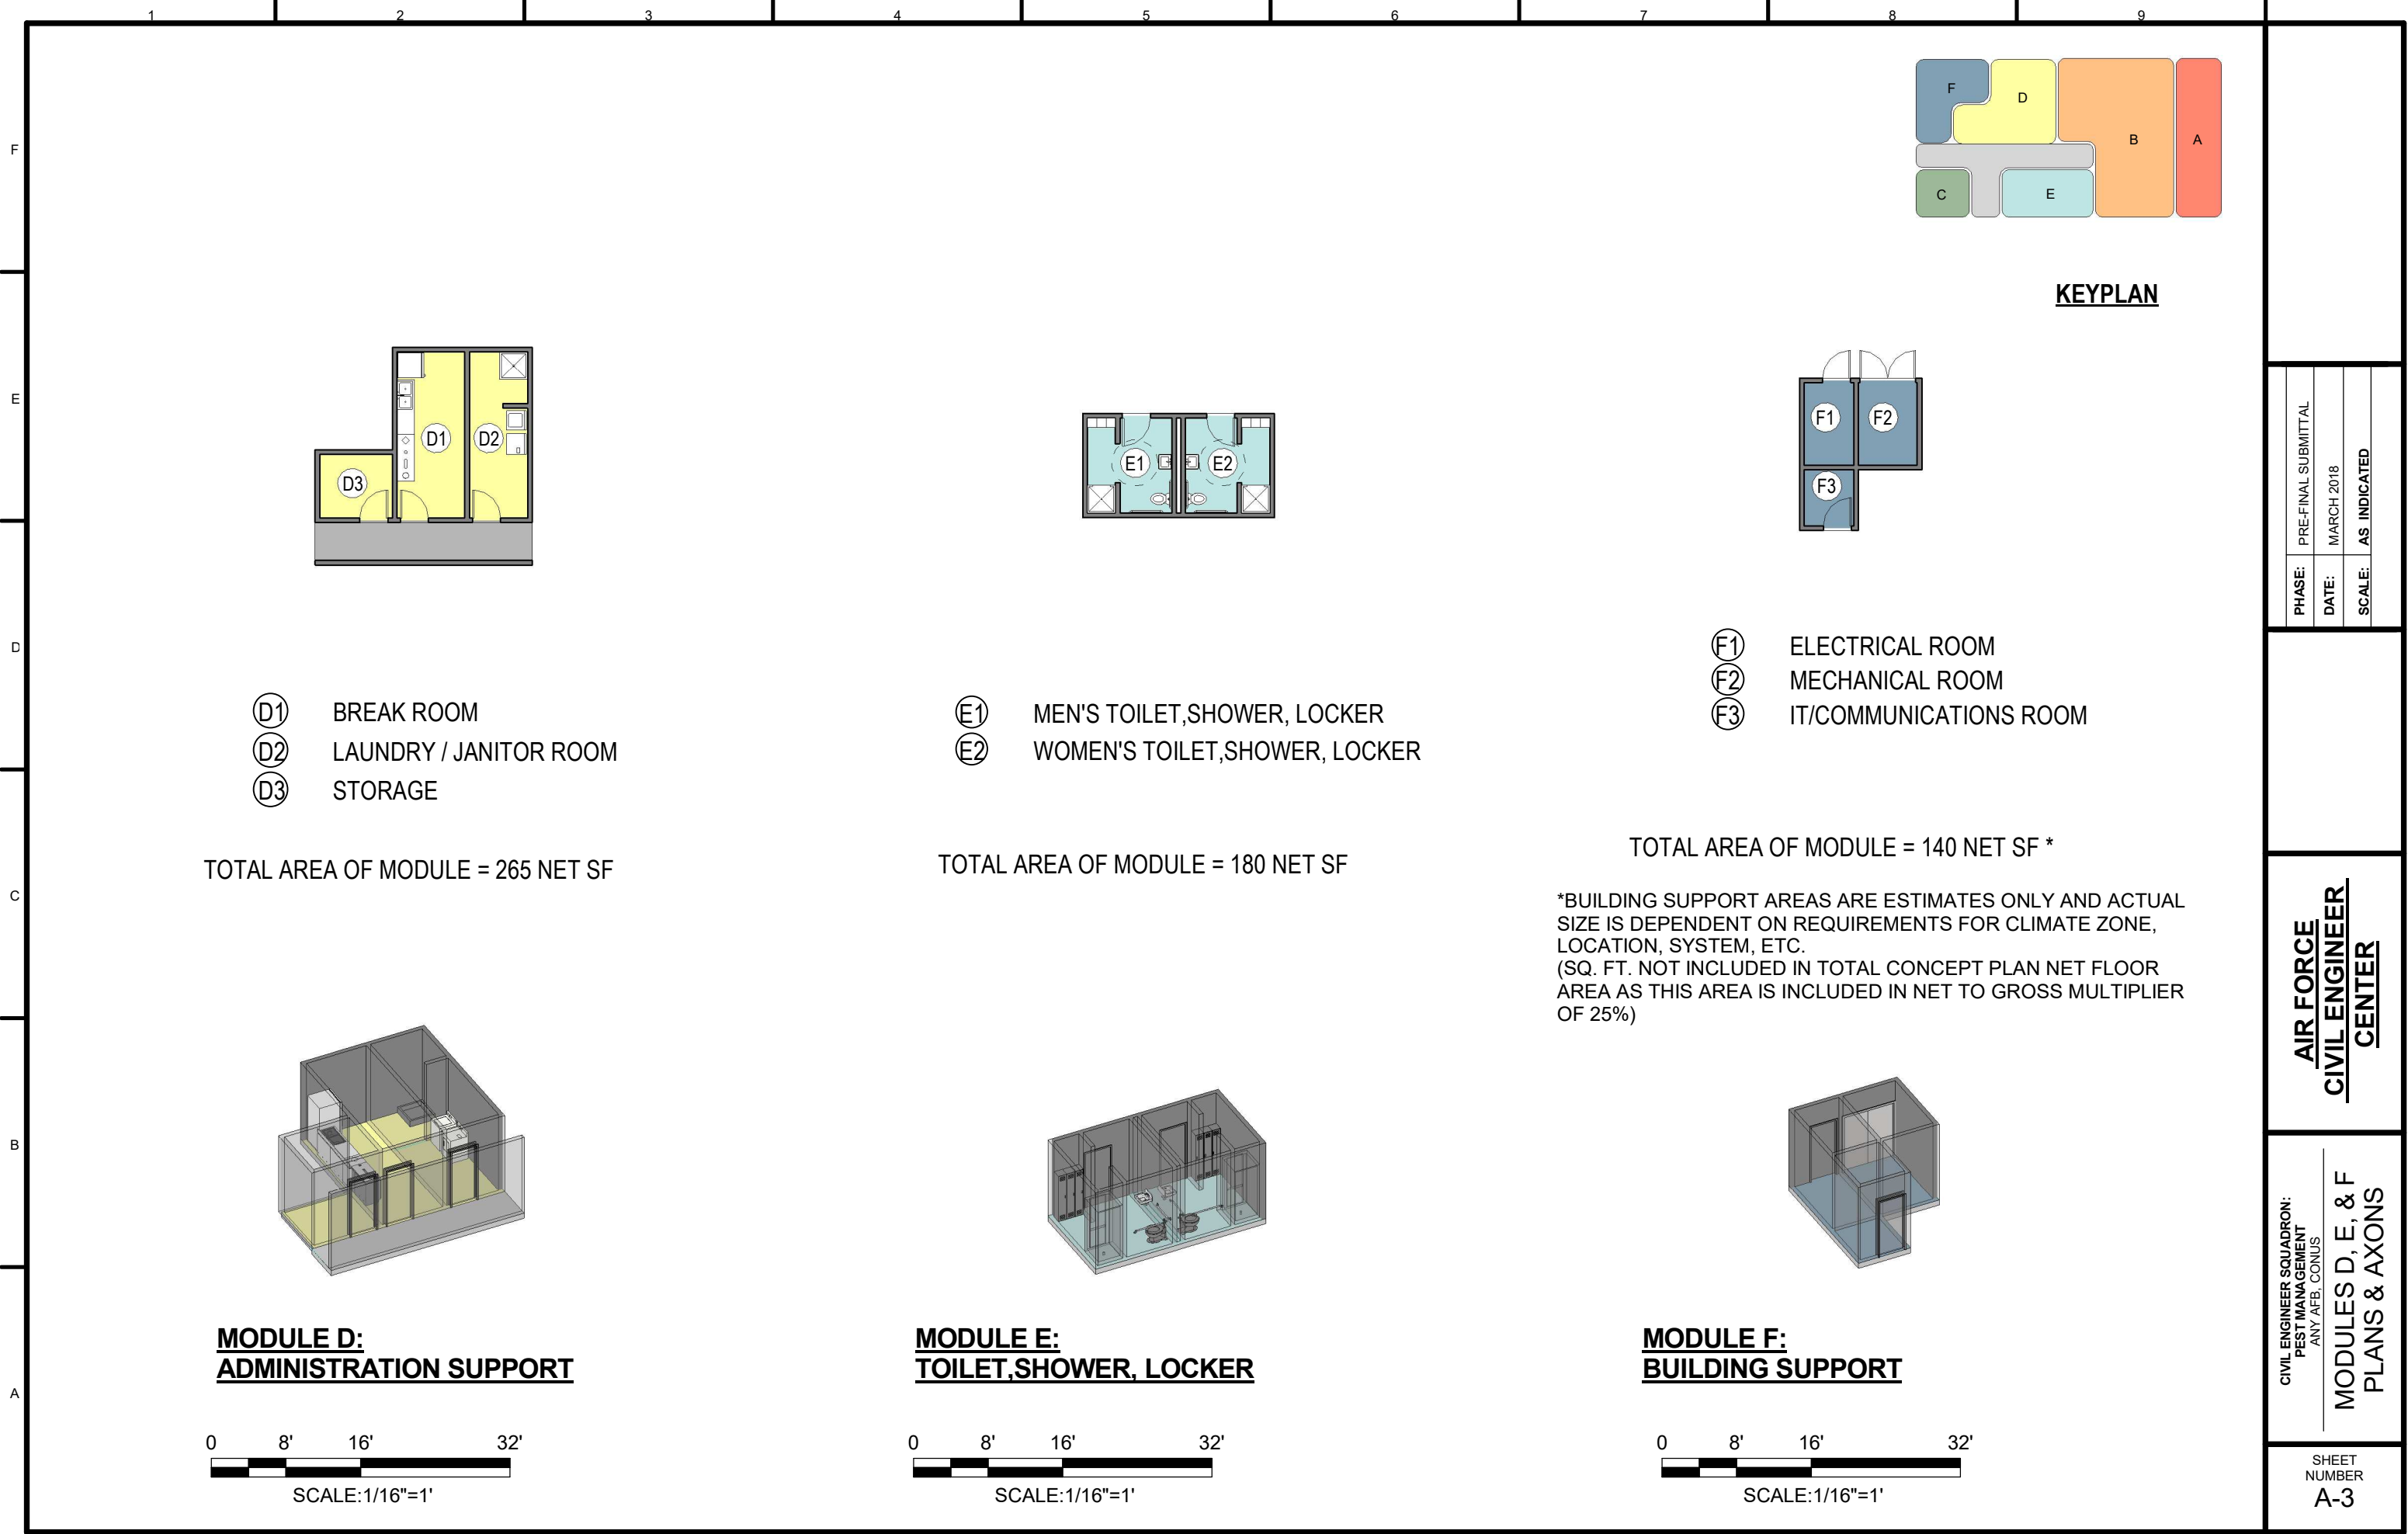CIVIL ENGINEER SQUADRON:
 PEST MANAGEMENT
 ANY AFB, CONUS
**MODULES D, E, & F
 PLANS & AXONS**

SHEET NUMBER
A-3